


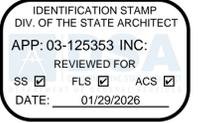

BONITA HIGH SCHOOL RUNNING TRACK REPLACEMENT

BONITA UNIFIED SCHOOL DISTRICT SAN DIMAS, CALIFORNIA



8816 Foothill Boulevard, Suite 103-224
Rancho Cucamonga, CA. 91730
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CONSULTANT:

CONSULTANTS STAMP:

SCHOOL DISTRICT:
**BONITA UNIFIED
SCHOOL DISTRICT**

PROJECT:
**BONITA
HIGH SCHOOL
RUNNING TRACK
REPLACEMENT**

BONITA HIGH SCHOOL
3102 D. STREET
LAVERNE, CA. 91750

JOB NUMBER: 12.01.06
DATE: 3/12/25

REVISION: DATE: _____
REVISION: DATE: _____


DRAWING TITLE:
TITLE SHEET

DRAWING NO.:

G1.0

ABBREVIATIONS	GENERAL NOTES	APPLICABLE CODES	PROJECT DIRECTORY	INDEX OF DRAWINGS
<p>ANGLE AT ~ CENTERLINE ~ DIAMETER OR ROUND A.B. ANCHOR BOLT A.F.F. ABOVE FINISH FLOOR A.G. ASPHALTIC CONCRETE ADJ. ADJACENT ALUM. ALUMINUM APPROX. APPROXIMATELY ARCH. ARCHITECT</p> <p>BD. BOARD BET. BETWEEN BLDG. BUILDING BLK. BLOCK BLKG. BLOCKING BM. BEAM</p> <p>CAB. CABINET C.B. CATCH BASIN C.F. CURB FACE C.J. CONTROL JOINT CLG. CEILING C.O. CONCRETE OPENING COL. COLUMN CONC. CONCRETE C.M.U. CONCRETE MASONRY UNITS COMPO. CONTINUOUS CONTR. CONTRACTOR CORR. CORRIDOR</p> <p>DET. DETAIL D.F. DRINKING FOUNTAIN D.G. DECOMPOSED GRANITE DIA. DIAMETER DIM. DIMENSION DIV. DIVISION DN. DOWN DBL. DOUBLE D.S. DOWNSPOUT DWG. DRAWING</p> <p>(E) EXISTING EA. EACH E.J. EXPANSION JOINT ELEC. ELECTRIC ELEV. ELEVATION ENT. ENTRANCE EMER. EMERGENCY ENCL. ENCLOSURE EQ. EQUAL EQUIP. EQUIPMENT E.G. EXISTING GRADE EXPO. EXPOSED EXP. EXPANSION EXT. EXTERIOR</p> <p>F.A. FLOOR DRAIN F.B. FIRE EXTINGUISHER F.B.C.A. FIRE EXTINGUISHER CABINET F.C. FINISH FLOOR F.D. FINISH GRADE F.E. FIRE HYDRANT F.E.W.S. FLATHEAD WOOD SCREWS FIN. FINISH F.L. FLOW LINE FLASH. FLASHING FLUOR. FLUORESCENT F.O.A. FACE OF CONCRETE F.O.F. FACE OF FINISH F.O.M. FACE OF MASONRY F.O.S. FACE OF STUD F.O.V.A. FACE OF VENEER F.R.A.B. FIRE RATED ASSEMBLY F.R.P.C. FIBERGLASS REINFORCED</p> <p>F.S. FLOOR SINK F.T. FOOT OR FEET FURR. FURRING GA. GAUGE GALV. GALVANIZED G.I. GALVANIZED IRON GL. GLASS GLU LAM. GLUE LAMINATED GND. GROUND GR. GRADE GR..A. GYPSUM</p> <p>H.B. HOSE BIB H.M. HOLLOW METAL HORIZ. HORIZONTAL HR. HOUR HT. HEIGHT HTG. HEATING HDWD. HARDWOOD</p> <p>I.D. INSIDE DIAMETER INSUL. INSULATION INT. INTERIOR INV. INVERT</p> <p>JAN. JANITOR LAB. LABORATORY PLAM. LAMINATED PLASTIC LAV. LAVATORY LVR. LOUVER</p> <p>MAR. MARBLE MATL. MATERIAL MAX. MAXIMUM MC. MEDICINE CABINET M.B.B. METAL CORNER BEAD MECH. MECHANICAL MET. METAL MFR. MANUFACTURER MIN. MINIMUM MISC. MISCELLANEOUS MO. MASONRY OPENING MTD. MOUNTED MUL. MULLION</p> <p>N. NORTH NAT. NATURAL N.G. NATURAL GRADE N.I.A. NOT IN CONTRACT NO. / # NUMBER NOM. NOMINAL N.T.S. NOT TO SCALE</p> <p>O.A. OVERALL OBS. OBSOLETE O.C. ON CENTER O.D. OUTSIDE DIAMETER O.H. OPPOSITE HAND O.P.G. OPENING OSA. OUTSIDE AIR</p> <p>PART. PARTITION P.H. PANIC HARDWARE PL. PLATE P.L. PROPERTY LINE PLAS.M. PLASTIC PLYWD. PLYWOOD PR. PAIR R. RISER RB. RUBBER BASE RAD.A. RADIUS RDWD. REDWOOD REF. REFERENCE RESIL. RESILIENT REV. REVERSE RM. ROOM R.O. ROUGH OPENING REFR. REFRIGERATOR REG. REGISTER REINF. REINFORCEMENT REQ'D. REQUIRED RO. ROUGH</p> <p>S. SOUTH SB. SPLASH BLOCK S.D. STORM DRAIN S.C. SOLID CORE SCHED. SCHEDULE SECT. SECTION SHT. SHEET SIM. SIMILAR S.J. SAW OR SCORE JOINT SLD'G. SLIDING SM. F. SMOOTH FACE S.M.S. SHEET-METAL SCREW SPEC. SPECIFICATIONS SP. F. SPLIT FACE SQ. SQUARE S.S. SERVICE SINK SST. STAINLESS STEEL STAT.A. STATIONARY STD. STANDARD STL. STEEL STRUCT. STRUCTURAL SUSP. SUSPENDED SYM. SYMMETRICAL</p> <p>T. TREAD T.B. TACKBOARD T.&B. TOP AND BOTTOM T.C. TOP OF CURB T.D. TOWEL DISPENSER T.G. TOP OF GRADE T.O.W. TOP OF MASONRY T.O.R. TOP OF ROOFING T.O.S. TOP OF SHEATHING T.P. TOP OF PAVING T.W. TOP OF WALL TEL. TELEPHONE TEMP. TEMPERATURE TR. TRANSOM TYP. TYPICAL</p> <p>UN.O. UNLESS NOTED OTHERWISE U.O.F. UNDERSIDE OF FRAME UR. URINAL</p> <p>VAR. VARIES V.C.T. VINYL COMPOSITION TILE VERT. VERTICAL VEST. VESTIBULE V.I.F. VERIFY IN FIELD</p> <p>W. WITH W.C. WATER CLOSET W. WOOD W.I. WROUGHT IRON</p>	<p>1. VERIFY ALL DIMENSIONS, LOCATIONS OF EXISTING UTILITIES, AND CONDITIONS ON JOB SITE PRIOR TO START OF WORK OR PORTIONS OF WORK. NOTIFY ARCHITECT IMMEDIATELY OF ANY DISCREPANCIES BETWEEN ACTUAL FIELD CONDITIONS AND CONSTRUCTION DOCUMENTS. EXISTING CONDITIONS ARE INDICATED AS RESULT OF FIELD OBSERVATIONS, INFORMATION SHOWN ON AVAILABLE DOCUMENTS AND FIELD CONDITIONS AT TIME OF PREPARATION.</p> <p>2. NOT ALL MECHANICAL, PLUMBING, AND ELECTRICAL ITEMS MAY BE SHOWN ON THE ARCHITECTURAL DRAWINGS</p> <p>3. ALL MATERIALS AND WORKMANSHIP SHALL COMPLY WITH ALL GOVERNING CODES, ORDINANCES, REGULATIONS AND LAWS.</p> <p>4. WHERE ANY CONFLICT OCCURS BETWEEN REQUIREMENTS OF LAWS, CODES, ORDINANCES, RULES AND REGULATIONS, THE MOST STRINGENT SHALL GOVERN.</p> <p>5. IN NO CASE SHALL WORKING DIMENSIONS BE SCALED FROM PLANS, SECTIONS OR DETAILS ON THE DRAWINGS.</p> <p>6. DETAILS MARKED WITH 'TYPICAL' SHALL APPLY IN ALL CASES UNLESS SPECIFICALLY NOTED OTHERWISE.</p> <p>7. ENACT ALL MEASURES TO PROTECT AND SAFEGUARD ALL EXISTING ELEMENTS TO REMAIN FROM BEING DAMAGED. REPLACE OR REPAIR EXISTING ELEMENTS DAMAGED BY THE EXECUTION OF THIS CONTRACT TO EQUAL OR BETTER CONDITION.</p> <p>8. CONTRACTOR SHALL COORDINATE BETWEEN THE REQUIREMENTS OF ALL DISCIPLINES HEREIN AND BETWEEN DRAWING AND SPECIFICATION REQUIREMENTS IN ORDER THAT ALL ITEMS RELATE TO ONE ANOTHER. NOTIFY ARCHITECT IMMEDIATELY REGARDING ANY ITEMS NOT COORDINATED.</p> <p>9. THE INTENT OF THESE DRAWINGS AND SPECIFICATIONS IS THAT THE WORK OF CONSTRUCTION, ALTERATION, REHABILITATION OR RECONSTRUCTION SHALL CONFORM TO TITLE 24, CALIFORNIA CODE OF REGULATION (CCR). SHOULD ANY EXISTING CONDITIONS SUCH AS DETERIORATION OR NON COMPLYING CONSTRUCTION BE DISCOVERED WHICH IS NOT COVERED BY THE CONTRACT DOCUMENTS WHEREIN THE FINISHED WORK WILL NOT COMPLY WITH THE TITLE 24, CALIFORNIA CODE OF REGULATIONS, A CONSTRUCTION CHANGE DOCUMENT (CCD) OR A SEPARATE SET OF PLANS AND SPECIFICATIONS, DETAILING AND SPECIFYING THE REQUIRED WORK SHALL BE SUBMITTED TO AND APPROVED BY THE DIVISION OF THE STATE ARCHITECT BEFORE PROCEEDING WITH THE WORK.</p> <p>10. CONTRACTOR SHALL STOP WORK AND NOTIFY ARCHITECT IMMEDIATELY IF ANY ASBESTOS CONTAINING MATERIAL (ACM) OR SUSPECTED ACM IS FOUND DAMAGED OR DISTURBED.</p> <p>11. CONTRACTOR SHALL EXERCISE EXTREME CAUTION IN EXCAVATING AND TRENCHING ON THIS SITE TO AVOID EXISTING DUCTS, PIPING, CONDUIT, ETC. AND TO PREVENT HAZARD TO PERSONNEL AND/OR TO EXISTING UNDERGROUND UTILITIES OR STRUCTURES. THE DESIGN PROFESSIONALS ARE NOT RESPONSIBLE FOR THE LOCATION OF UNDERGROUND UTILITIES OR STRUCTURES, WHETHER OR NOT SHOWN ON AND INSTALLED BY THESE CONTRACT DOCUMENTS. THE CONTRACTOR SHALL IMMEDIATELY NOTIFY THE DISTRICT SHOULD SUCH UNIDENTIFIED CONDITIONS BE DISCOVERED. THESE DRAWINGS AND SPECIFICATIONS DO NOT INCLUDE THE NECESSARY COMPONENTS FOR CONSTRUCTION SAFETY.</p> <p>12. CHANGES TO THE APPROVED DRAWINGS AND SPECIFICATIONS SHALL BE MADE BY ADDENDA OR A CONSTRUCTION CHANGE DOCUMENT (CCD). APPROVED BY DIVISION OF THE STATE ARCHITECT, AS REQUIRED BY SECTION 4-338, PART 1, TITLE 24, CCP.</p> <p>13. WORK SHALL COMPLY WITH THE PREVISIONS OF CHAPTER 33 OF CBC & CFC, 2020 EDITION, "FIRE SAFETY DURING CONSTRUCTION AND DEMOLITION".</p> <p>14. THE ACCEPTANCE TESTING PROCEDURES MUST BE REPEATED, AND DEFICIENCIES MUST BE CORRECTED BY THE BUILDER OR INSTALLING CONTRACTOR UNTIL THE CONSTRUCTION INSTALLATION OF THE SPECIFIED SYSTEMS CONFORM AND PASS THE REQUIRED ACCEPTANCE CRITERIA.</p> <p>15. PROJECT INSPECTORS WILL COLLECT THE FORMS TO CONFIRM THAT THE REQUIRED ACCEPTANCE TEST HAVE BEEN COMPLETED.</p> <p>16. A WRITTEN SITE SAFETY PLAN IN COMPLIANCE WITH C.F.C. 3303.1 MUST BE PREPARED AND LABELED ON SITE PRIOR TO COMMENCEMENT OF ANY MOBILIZATION, DEMOLITION AND/OR CONSTRUCTION.</p> <p>17. GRADING PLANS, DRAINAGE IMPROVEMENTS, ROAD AND ACCESS REQUIREMENTS AND ENVIRONMENTAL HEALTH CONSIDERATIONS SHALL COMPLY WITH LOCAL ORDINANCES.</p> <p>18. ALL WORK SHALL CONFORM TO 2022 TITLE 24, CALIFORNIA CODE OF REGULATIONS (CCR)</p> <p>19. A DSA ACCEPTED TESTING LABORATORY DIRECTLY EMPLOYED BY DISTRICT (OWNER) SHALL CONDUCT ALL THE REQUIRED TESTS AND INSPECTIONS FOR THE PROJECT.</p>	<p>PARTIAL LIST OF APPLICABLE CODES AS OF January 1, 2022*</p> <p>2022 California Administrative Code (CAC), Part 1, Title 24 CCR*</p> <p>2022 California Building Code (CBC), Part 2, Title 24 CCR</p> <p>2022 California Electrical Code (CEC), Part 3, Title 24 CCR</p> <p>2022 California Mechanical Code (CMC), Part 4, Title 24 CCR</p> <p>2022 California Plumbing Code (CPC), Part 5, Title 24 CCR</p> <p>2022 California Energy Code (CEC), Part 6, Title 24 CCR</p> <p>2022 California Fire Code (CFC), Part 9, Title 24 CCR</p> <p>2022 California Existing Building Code (CEBC), Part 10, Title 24 CCR</p> <p>2022 California Green Building Standards Code (CALGreen), Part 11, Title 24 CCR</p> <p>2022 California Referenced Standards Code, Part 12, Title 24 CCR</p> <p>Title 19 CCR, Public Safety, State Fire Marshal Regulations</p> <p>PARTIAL LIST OF APPLICABLE STANDARDS</p> <p>For a list of applicable standards, California amendments to the NFPA Standards, refer to CBC Chapter 35 and CFC Chapter 80.</p>	<p>DISTRICT BONITA UNIFIED SCHOOL DISTRICT 115 W. ALLEN AVENUE SAN DIMAS, CA 91773</p> <p>SCHOOL BONITA HIGH SCHOOL 3102 D. STREET LAVERNE, CA. 91750</p> <p>ARCHITECT ARCHITECTURE 9, PLLLP 8816 FOOTHILL BOULEVARD, SUITE 103-224 RANCHO CUCAMONGA, CA. 91730 contact@architecture9.com</p>	<p>GENERAL</p> <p>G1.0 TITLE SHEET</p> <p>ARCHITECTURAL</p> <p>A1.1 OVERALL SITE PLAN A1.2 ENLARGED SITE PLAN A1.3 ENLARGED ACCESSIBLE PARKING A1.4 SITE DETAILS A1.5 SITE DETAILS A1.6 SITE DETAILS A2.0 ENLARGED FLOOR PLANS A2.1 ENLARGED FLOOR PLANS AND ELEVATIONS BLDG. O A2.2 ENLARGED FLOOR PLANS AND ELEVATIONS BLDG. K A3.0 INTERIOR ELEVATIONS A3.OA MOUNTING HEIGHTS A6.0 SIGNAGE & DOOR SCHEDULE</p>
		<p>DSA INSPECTOR</p> <p>A CLASS 3 PROJECT INSPECTOR EMPLOYED BY THE DISTRICT AND APPROVED BY THE DIVISION OF THE STATE ARCHITECT SHALL PROVIDE CONTINUOUS INSPECTION OF THE WORK. THE DUTIES OF THE INSPECTOR ARE DEFINED IN SECTIONS 4-342, PART 1, TITLE 24, CCR.</p>	<p>VICINITY MAP</p>	<p>PROJECT DESCRIPTION</p> <p>REPLACEMENT OF (E) SYNTHETIC RUNNING TRACK, ACCESSIBLE PARKING STRIPING REPAINT AND RELATED PATH OF TRAVEL IMPROVEMENTS</p>
		<p>UNCERTIFIED A#S</p> <p>62918 UNKNOWN SCOPE 03-111634 COMMUNICATION EQUIPMENT MASONRY ENCLOSURE AND MONO POLE 03-116146 ANTENNA MONO POLE (A# 03-101575)</p>		

Exhibit A - Drawings

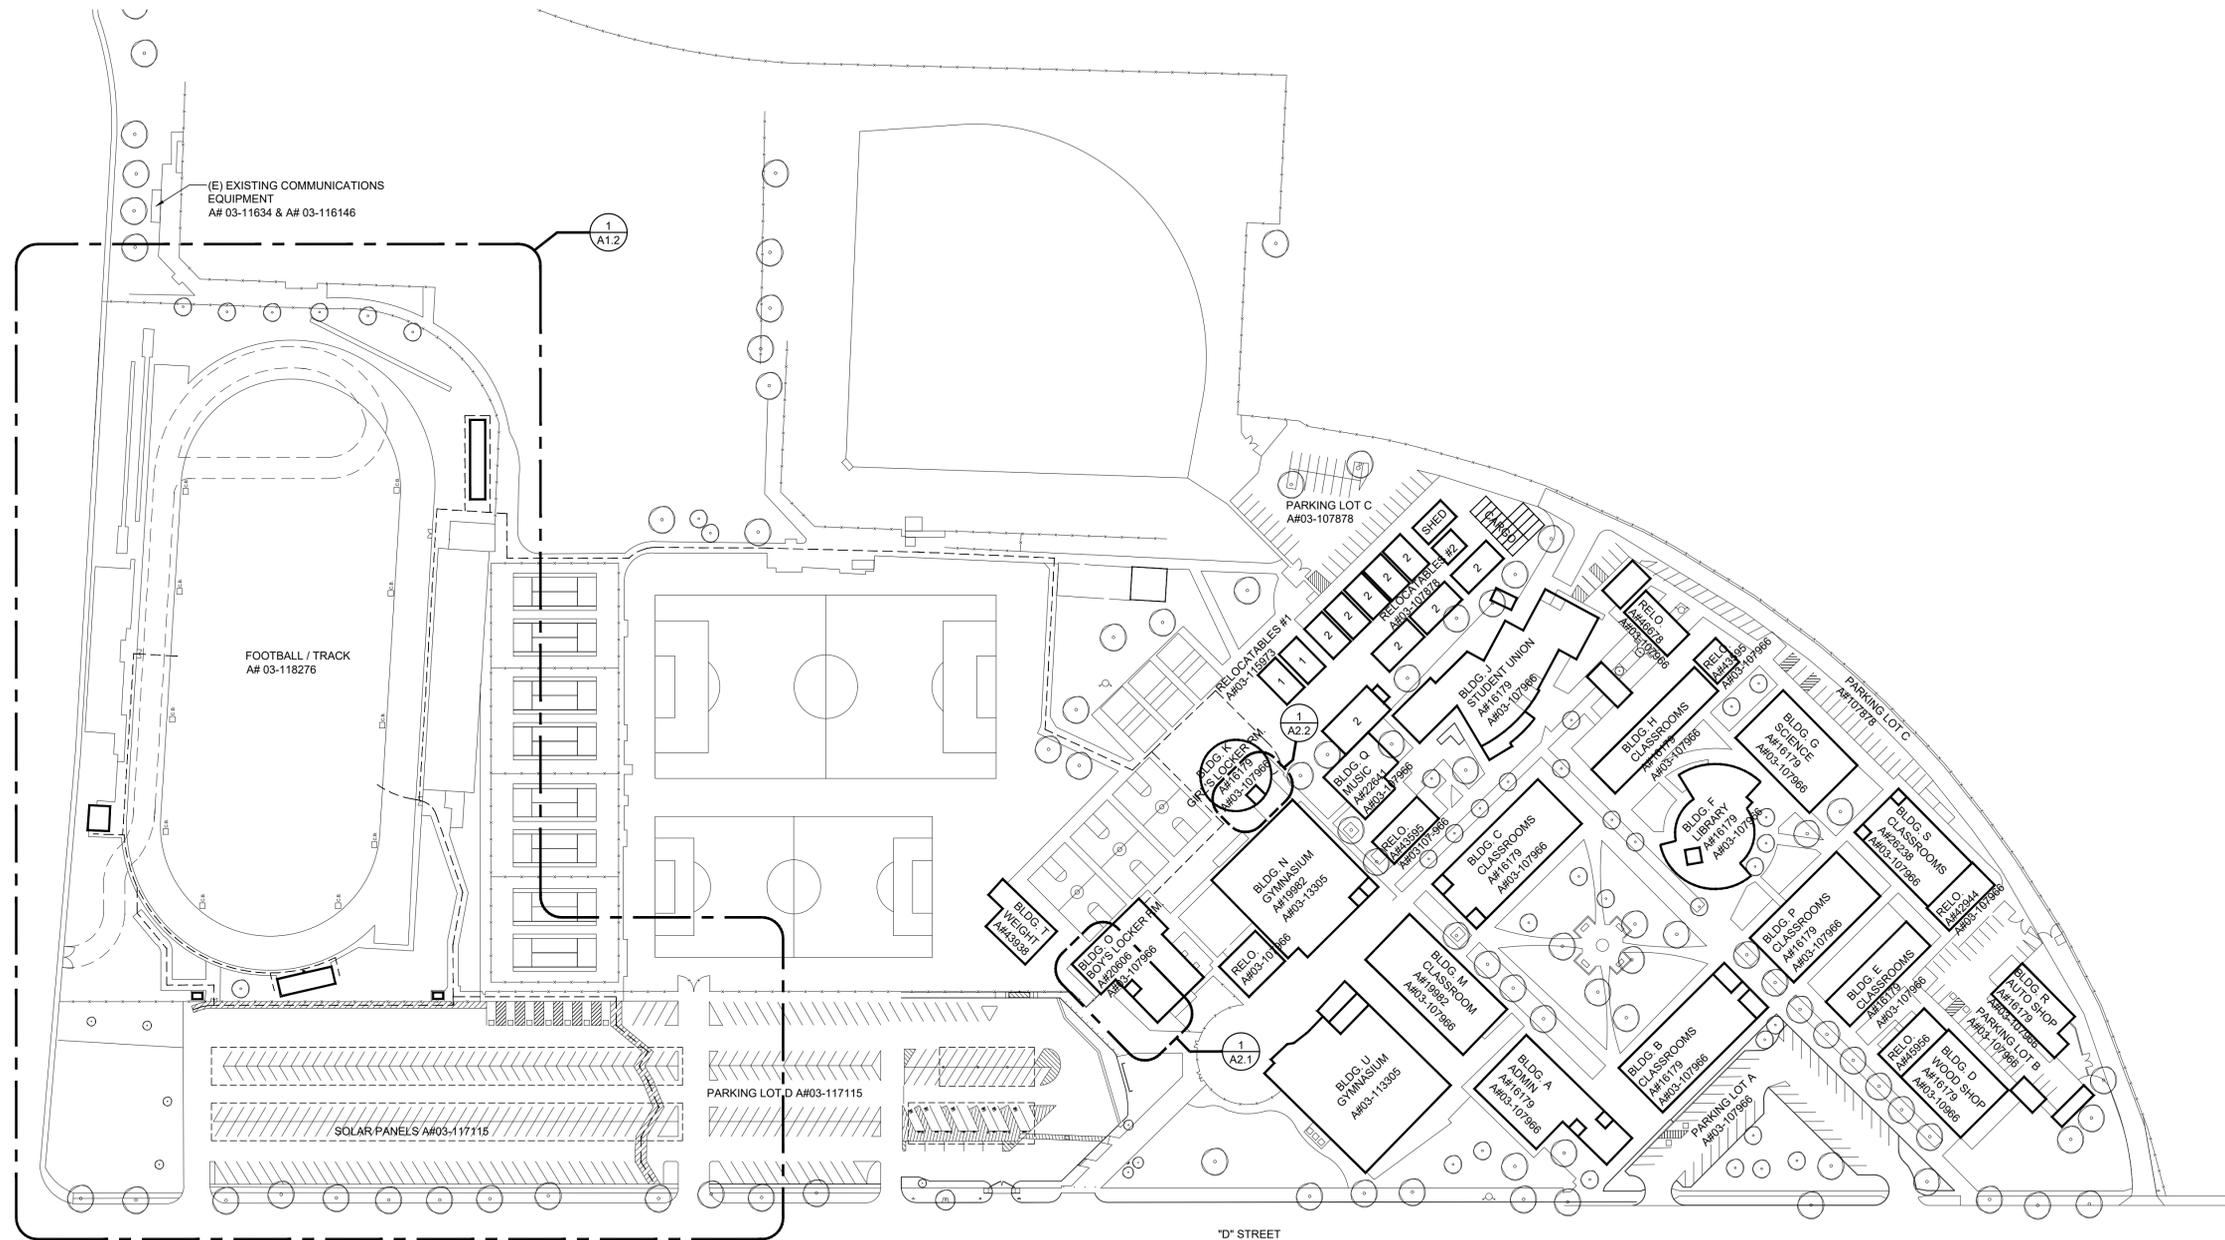

1 OVERALL SITE PLAN
SCALE: 1" = 80'
NORTH

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a9contact@architecture9.com

ARCHITECTS STAMP:

CONSULTANT:

CONSULTANTS STAMP:

SCHOOL DISTRICT:
BONITA UNIFIED SCHOOL DISTRICT

PROJECT:
BONITA HIGH SCHOOL RUNNING TRACK REPLACEMENT
BONITA HIGH SCHOOL
3102 D. STREET
LAVERNE, CA. 91750

JOB NUMBER: 12.01.06
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DRAWING TITLE:
OVERALL SITE PLAN

DRAWING NO.:
A1.1

LEGEND	
	EXISTING PATH OF TRAVEL A#03-118276

DESIGN PROFESSIONAL IN GENERAL RESPONSIBLE CHARGE STATEMENT:


"THE P.O.T. IDENTIFIED IN THESE CONSTRUCTION DOCUMENTS IS COMPLIANT WITH THE CURRENT APPLICABLE CALIFORNIA BUILDING CODE ACCESSIBILITY PROVISIONS FOR PATH OF TRAVEL REQUIREMENTS FOR ALTERATIONS, ADDITIONS AND STRUCTURAL REPAIRS. AS PART OF THE DESIGN OF THIS PROJECT, THE P.O.T. WAS EXAMINED AND ANY ELEMENTS, COMPONENTS, OR PORTIONS OF THE P.O.T. THAT WERE DETERMINED TO BE NONCOMPLIANT 1) HAVE BEEN IDENTIFIED AND 2) THE CORRECTIVE WORK NECESSARY TO BRING THEM INTO COMPLIANCE HAS BEEN INCLUDED WITHIN THE SCOPE OF THIS PROJECT'S WORK THROUGH DETAILS, DRAWINGS AND SPECIFICATIONS INCORPORATED INTO THESE CONSTRUCTION DOCUMENTS. ANY NONCOMPLIANT ELEMENTS, FINDING OF UNREASONABLE HARDSHIP ARE SO INDICATED IN THESE CONSTRUCTION DOCUMENTS.

DURING CONSTRUCTION, IF P.O.T. ITEMS WITHIN THE SCOPE OF THE PROJECT REPRESENTED AS CODE COMPLIANT ARE FOUND TO BE NONCONFORMING BEYOND REASONABLE CONSTRUCTION TOLERANCES, THEY SHALL BE BROUGHT INTO COMPLIANCE WITH THE CBC AS A PART OF THIS PROJECT BY MEANS OF A CONSTRUCTION CHANGE DOCUMENT."

PATH OF TRAVEL TECHNICAL REQUIREMENTS FOR ACCESSIBLE ROUTE

"ACCESSIBLE PATH OF TRAVEL AS INDICATED ON PLAN IS A BARRIER-FREE ACCESS ROUTE WITHOUT ABRUPT LEVEL CHANGES EXCEEDING 1/2" IF BEVELED AT 1:2 MAXIMUM SLOPE OR VERTICAL LEVEL CHANGES NOT EXCEEDING 1/4" MAXIMUM AND AT LEAST 48" IN WIDTH. SURFACE IS STABLE, FIRM, AND SLIP-RESISTANT. CROSS-SLOPE SHALL NOT BE STEEPER THAN 1:48 AND SLOPE IN THE DIRECTION OF THE TRAVEL SHALL NOT BE STEEPER THAN 1:20. ACCESSIBLE PATH OF TRAVEL SHALL BE MAINTAINED FREE OF OVERHANGING OBSTRUCTIONS TO 80" MINIMUM AND FREE OF OBJECTS PROTRUDING MORE THAN 4" FROM THE WALL, ABOVE 27" AND LESS THAN 80" ABOVE THE FLOOR. ARCHITECT HAS VERIFIED THAT THERE ARE NO BARRIERS IN THE PATH OF TRAVEL."

Exhibit A - Drawings

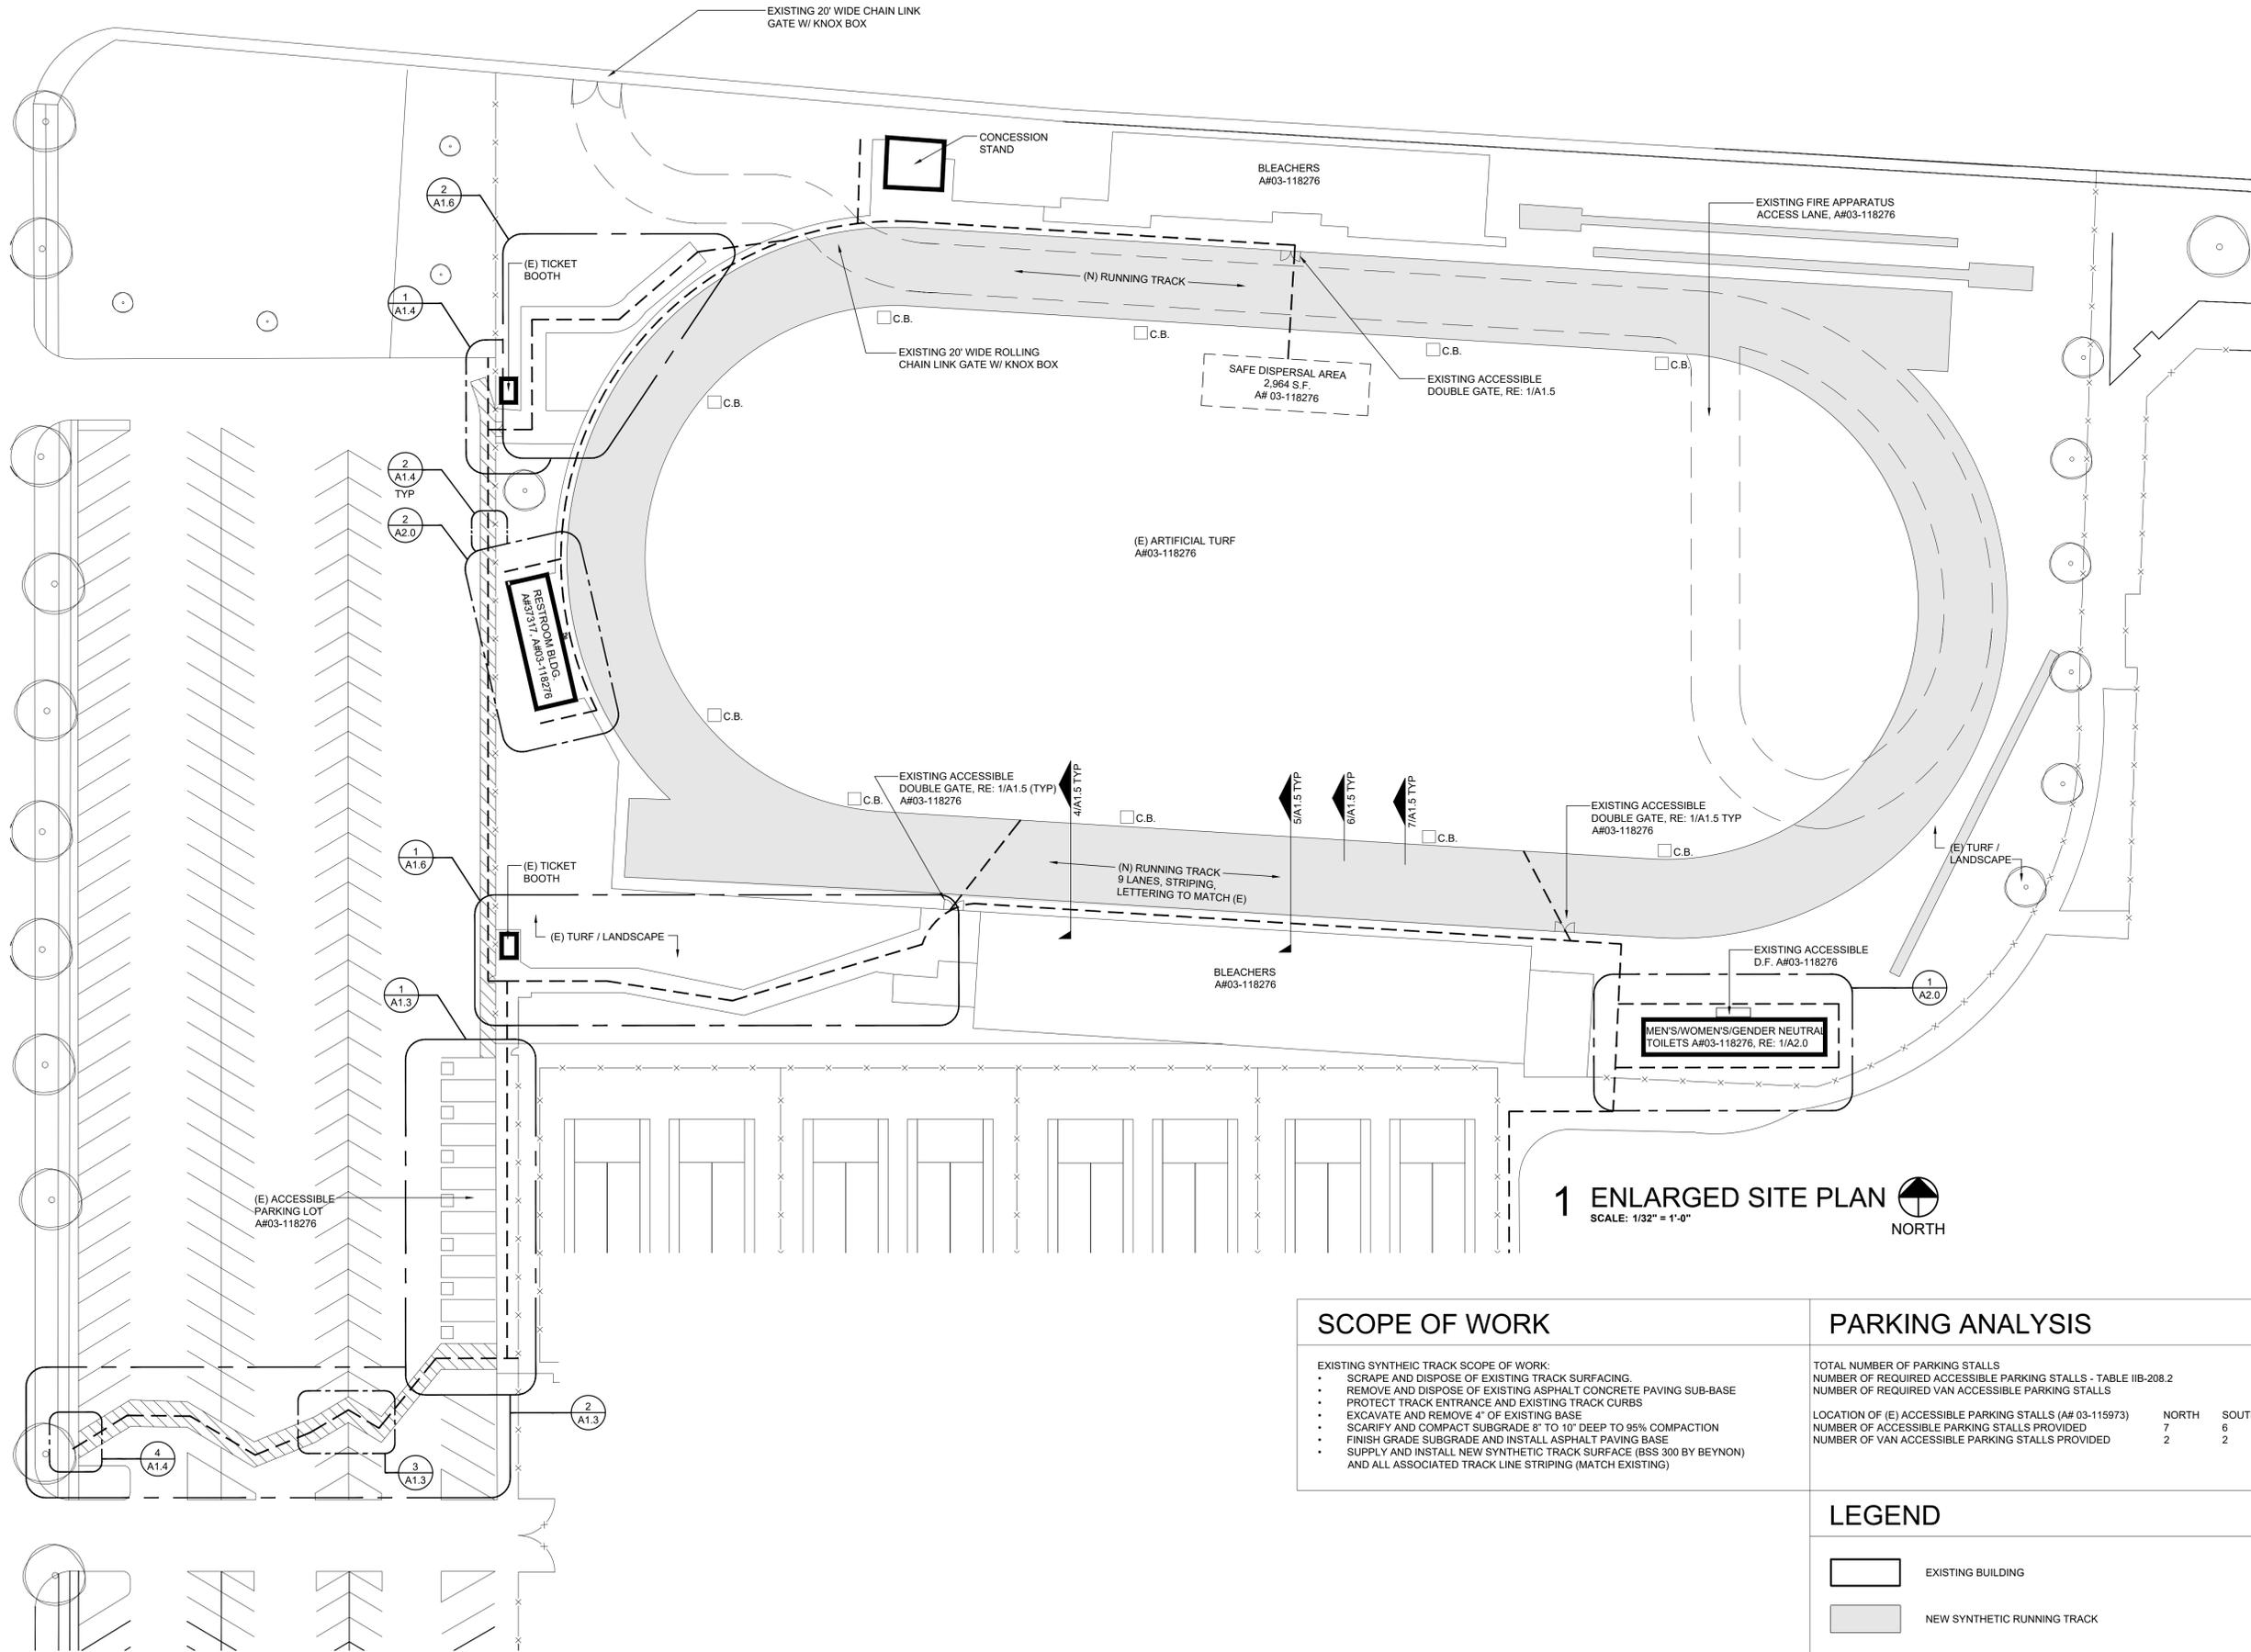

1 ENLARGED SITE PLAN
SCALE: 1/32" = 1'-0"
NORTH

SCOPE OF WORK
EXISTING SYNTHETIC TRACK SCOPE OF WORK:
• SCRAPE AND DISPOSE OF EXISTING TRACK SURFACING.
• REMOVE AND DISPOSE OF EXISTING ASPHALT CONCRETE PAVING SUB-BASE
• PROTECT TRACK ENTRANCE AND EXISTING TRACK CURBS
• EXCAVATE AND REMOVE 4" OF EXISTING BASE
• SCARIFY AND COMPACT SUBGRADE 8" TO 10" DEEP TO 95% COMPACTION
• FINISH GRADE SUBGRADE AND INSTALL ASPHALT PAVING BASE
• SUPPLY AND INSTALL NEW SYNTHETIC TRACK SURFACE (BSS 300 BY BEYNON) AND ALL ASSOCIATED TRACK LINE STRIPING (MATCH EXISTING)

PARKING ANALYSIS			
TOTAL NUMBER OF PARKING STALLS			319
NUMBER OF REQUIRED ACCESSIBLE PARKING STALLS - TABLE IIB-208.2			8
NUMBER OF REQUIRED VAN ACCESSIBLE PARKING STALLS			2
LOCATION OF (E) ACCESSIBLE PARKING STALLS (A# 03-115973)	NORTH	SOUTH	TOTAL
NUMBER OF ACCESSIBLE PARKING STALLS PROVIDED	7	6	13
NUMBER OF VAN ACCESSIBLE PARKING STALLS PROVIDED	2	2	4

LEGEND	
	EXISTING BUILDING
	NEW SYNTHETIC RUNNING TRACK
	EXISTING PATH OF TRAVEL (A#03-118276)
	EXISTING CATCH BASIN A#03-118276

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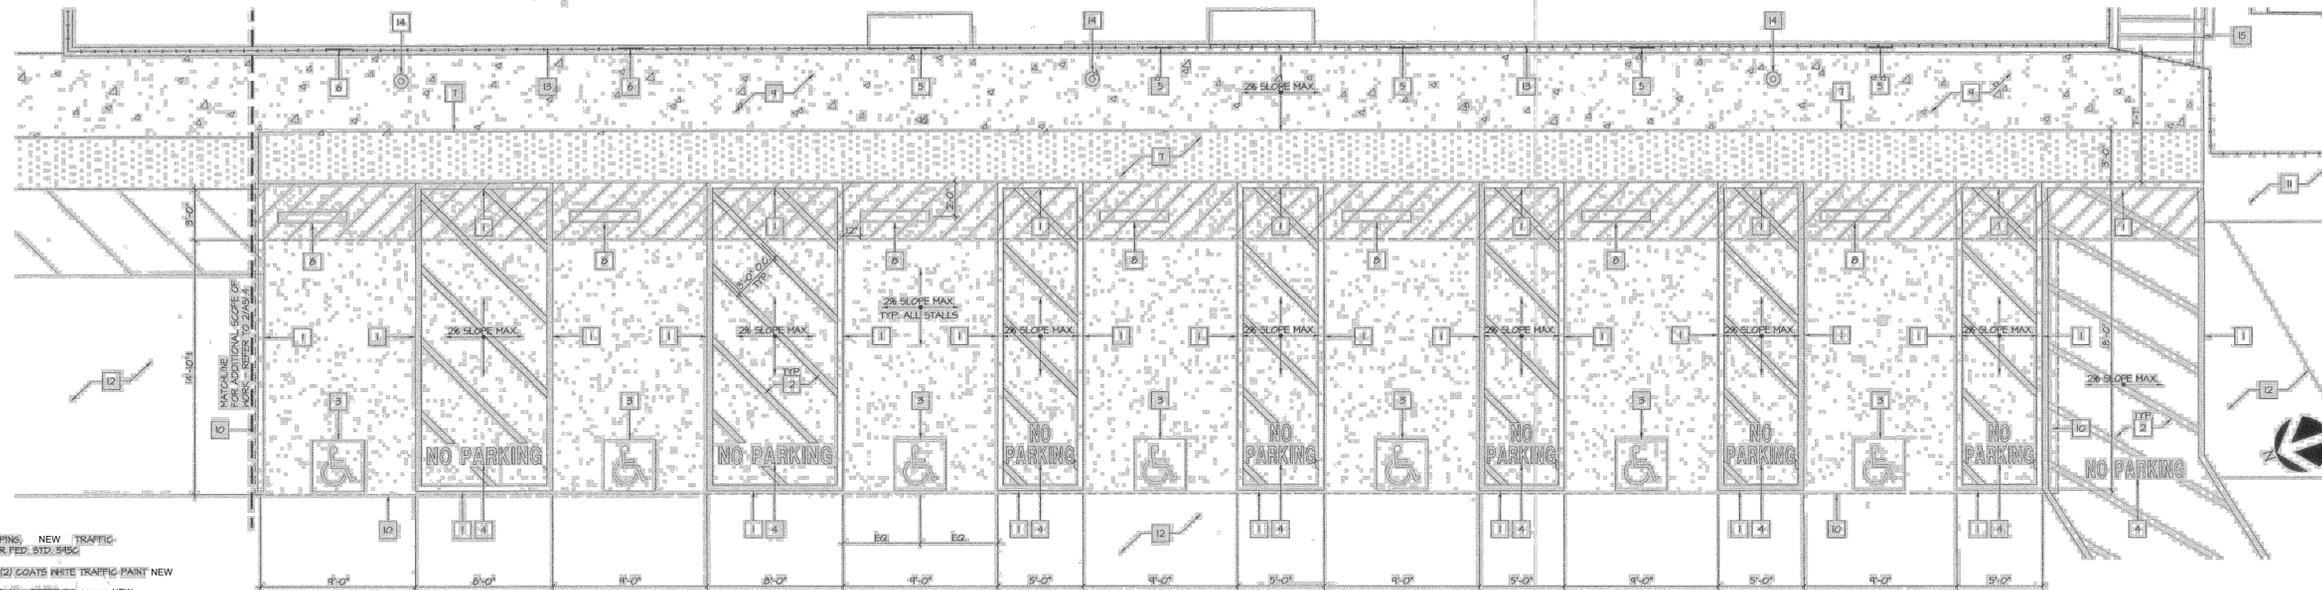
PROJECT:
BONITA HIGH SCHOOL RUNNING TRACK REPLACEMENT
BONITA HIGH SCHOOL
3102 D. STREET
LAVERNE, CA. 91750

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DRAWING TITLE:
ENLARGED SITE PLAN

DRAWING NO.:
A1.2

Exhibit A - Drawings




CONSTRUCTION KEYNOTES

- 1 4" WIDE PERIMETER & PARKING STRIPING, NEW TRAFFIC BEARING BLUE, COLOR NO. 15040 PER FED. STD. 545C
- 2 4" WIDE HATCH STRIPING @ 36" O.C., (2) COATS WHITE TRAFFIC PAINT NEW
- 3 TYPICAL ACCESSIBILITY PAVEMENT SIGN - REFER TO 8/A1.4-NEW
- 4 12" HIGH MIN. & 3" WIDE BLOCK LETTERS PAINTED WITH WHITE TRAFFIC PAINT, NEW
- 5 EXISTING ACCESSIBLE PARKING SIGNAGE ON FENCE - REFER TO 5/A1.4
- 6 EXISTING ACCESSIBLE VAN PARKING SIGNAGE ON FENCE - REFER TO 5/A1.4
- 7 EXISTING PAVEMENT DOMES - REFER TO 3/A1.4
- 8 (E) WHEEL STOP - PER FED. STD. 545C
- 9 4" CONG. PAVING, EXISTING MEDIUM BROOM FINISH PERPENDICULAR TO THE DIRECTION OF TRAFFIC
- 10 EXTENT OF PAVING
- 11 (E) CONCRETE PAVING
- 12 (E) AC PAVING
- 13 (E) CHAINLINK FENCING
- 14 (E) LIGHT POST
- 15 (E) CONCRETE STAIRS

LEGEND:

- (E) 4" CONG. SLAB RAMP W/
- (E) ASPHALT PAVING
- (E) VARIABLE DEPTH ASPHALT PAVING

1 ACCESSIBLE PARKING
SCALE: N.T.S. 2/AS1.10 (E) 03-118276

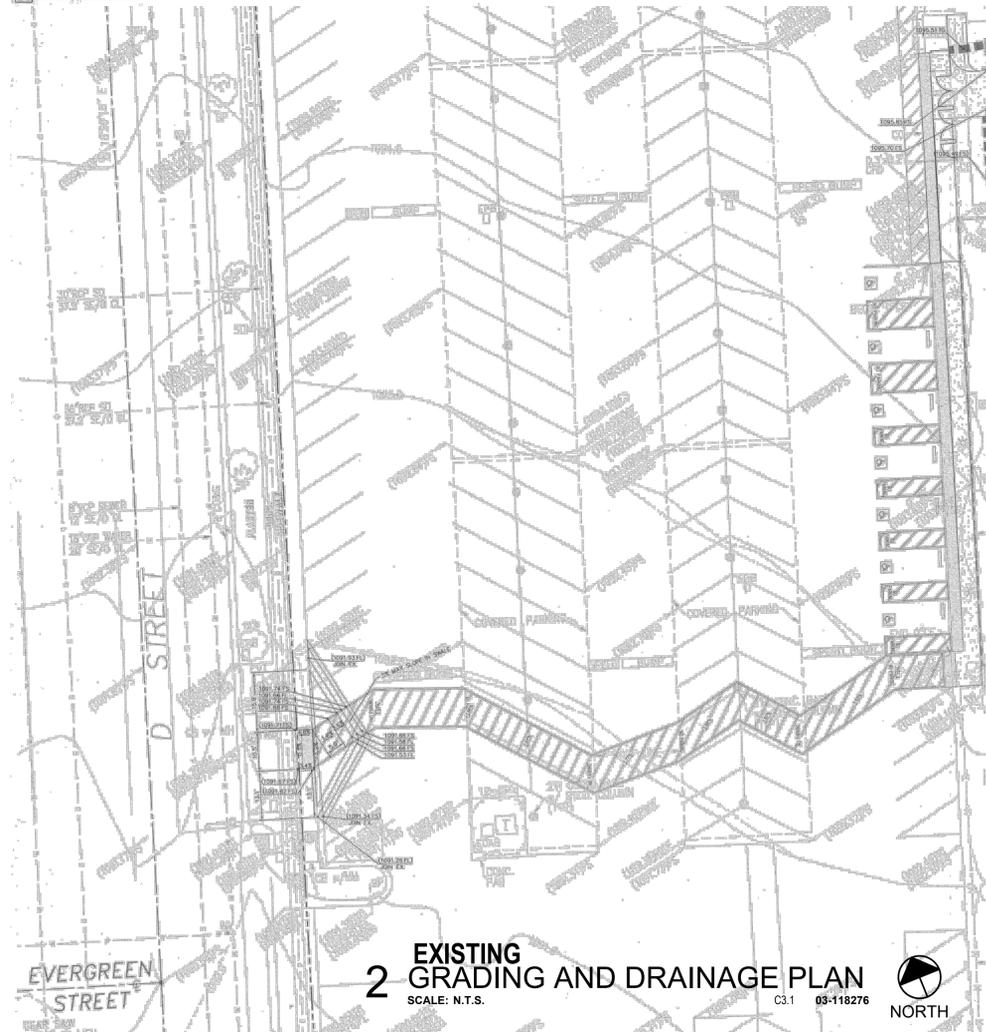


2 EXISTING GRADING AND DRAINAGE PLAN
SCALE: N.T.S. C3.1 03-118276



LEGEND:

- PROPERTY LINE
- RIGHT-OF-WAY LINE
- OWNER LINE
- EXIST. LIMIT OF WORK LINE
- SMALLE
- PROPOSED VALLEY GUTTER
- GRADE WEDGE LINE
- ROAD BANK
- EXISTING SPOT GRADE
- PROPOSED SPOT GRADE
- PROPOSED FILL (EXCEPT FOR FILL)

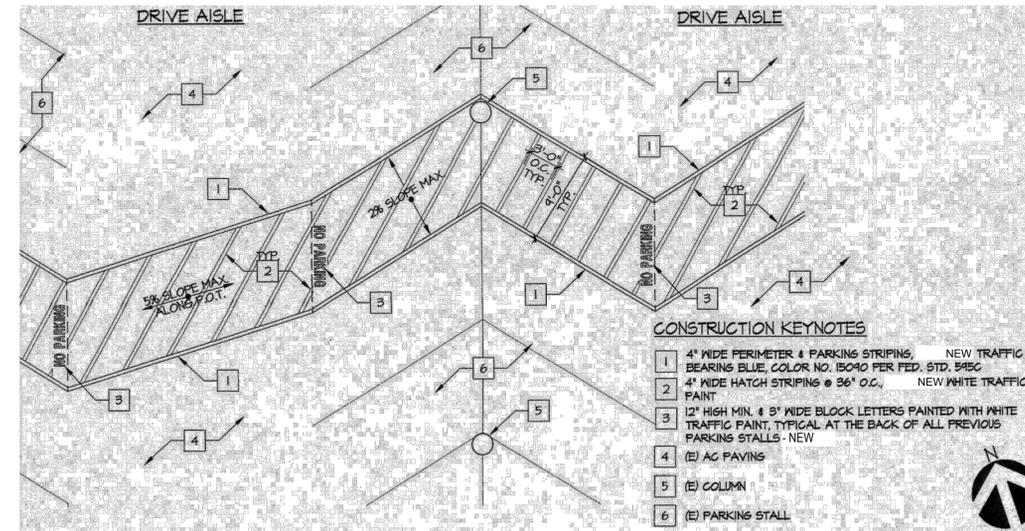

CONSTRUCTION KEYNOTES

- 1 4" WIDE PERIMETER & PARKING STRIPING, NEW TRAFFIC BEARING BLUE, COLOR NO. 15040 PER FED. STD. 545C
- 2 4" WIDE HATCH STRIPING @ 36" O.C., NEW WHITE TRAFFIC PAINT
- 3 12" HIGH MIN. & 3" WIDE BLOCK LETTERS PAINTED WITH WHITE TRAFFIC PAINT, TYPICAL AT THE BACK OF ALL PREVIOUS PARKING STALLS - NEW
- 4 (E) AC PAVING
- 5 (E) COLUMN
- 6 (E) PARKING STALL

3 ACCESSIBLE P.O.T. @ PARKING LOT
SCALE: N.T.S. 4/A1.9 (E) 03-118276



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ACCESSIBLE PARKING

DRAWING NO.:

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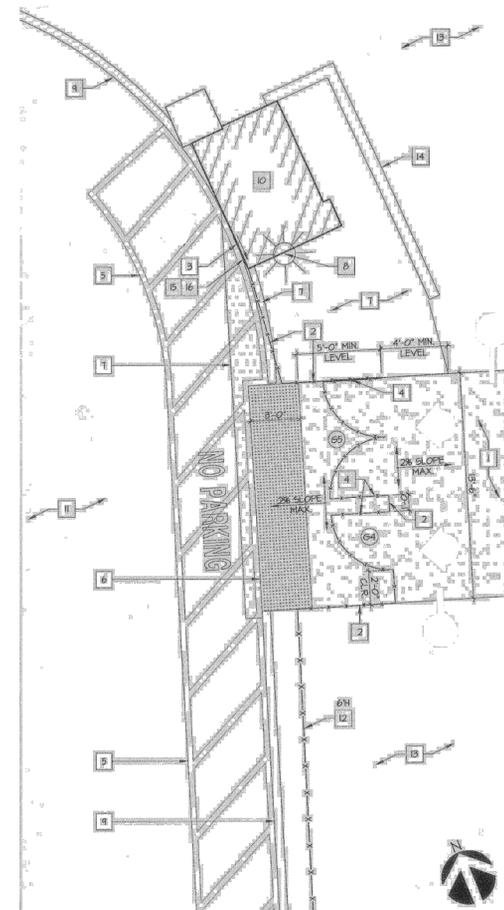
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REVISION: Δ DATE: _____
REVISION: Δ DATE: _____

DRAWING TITLE:
SITE DETAILS

DRAWING NO.:


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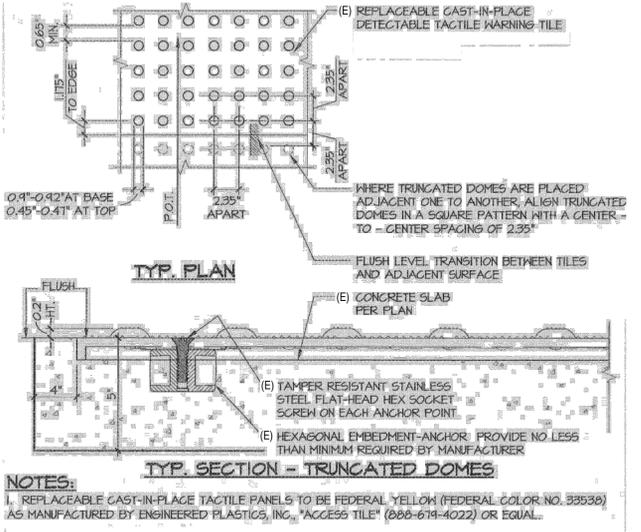
- CONSTRUCTION NOTES**
- 4" CONC. PAVING - EXISTING PERPENDICULAR TO THE DIRECTION OF PATH
 - 6" HIGH CHAINLINK FENCING - EXISTING TO REMAIN
 - DIRECTIONAL SIGNAGE FOR ACCESSIBLE TICKET BOOTH RE: 6/A1.4 - EXISTING TO REMAIN
 - ACCESSIBLE PEDESTRIAN GATES/RY PVC HARDWARE - RE: 2/A1.5 - EXISTING TO REMAIN
 - 8" WIDE STRIPING FOR ACCESSIBLE POT - EXISTING TO REMAIN
 - TRUNCATED DOMES RE: 3/A1.4 - EXISTING TO REMAIN
 - AC PAVING - EXISTING TO REMAIN
 - SITE LIGHT - TO REMAIN, PROTECT IN PLACE.
 - CONCRETE PAVING/CURB
 - TICKET BOOTH
 - AC PAVING
 - CHAINLINK FENCING REFER TO KEYNOTE FOR FENCE HEIGHT
 - VEGETATION AND TURF
 - CHP/LOW WALL
 - ASSISTED LISTENING SYSTEM SIGN - EXISTING
 - ACCESSIBLE DESIGNATED AISLE SEATING SIGN - EXISTING

- LEGEND**
- 4" THK. CONCRETE PAVING W/ 8" x 16" O.C. EACH WAY - EXISTING
 - AC PAVING - EXISTING
 - EXISTING BUILDING
 - CHAINLINK FENCING & GATES - EXISTING TO REMAIN
 - CHAINLINK TECHNIQUES/GATES
 - GATE SYMBOL


1 EXISTING SITE AT VISITORS ENTRANCE
SCALE: N.T.S. 4/A1.4 A#03-118276




2 ACCESSIBLE DRIVE AISLE
SCALE: N.T.S. 1/A1.6 A#03-118276

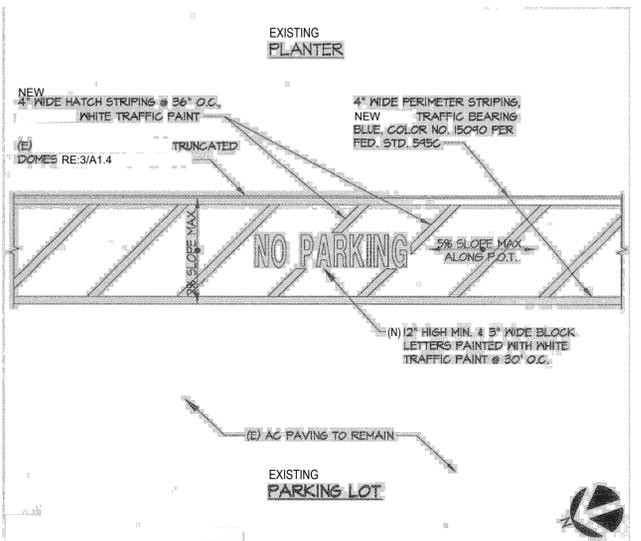


3 EXISTING TRUNCATED DOMES
SCALE: N.T.S. 2/A1.6 A#03-118276

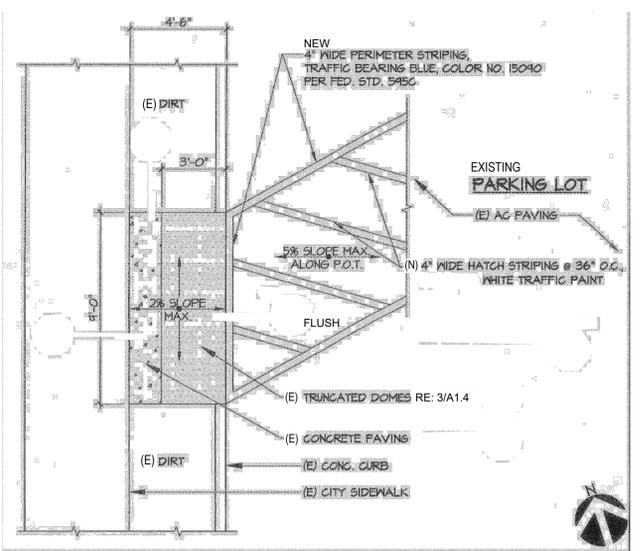


4 CONC. PAVING @ CITY SIDEWALK
SCALE: N.T.S. 3/A1.6 A#03-118276

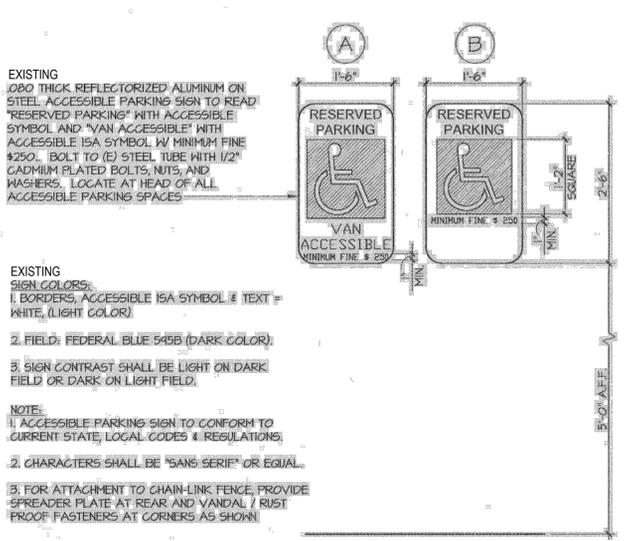


5 EXISTING ACCESSIBILITY PARKING SIGNS
SCALE: N.T.S. 8/A1.6 A#03-118276

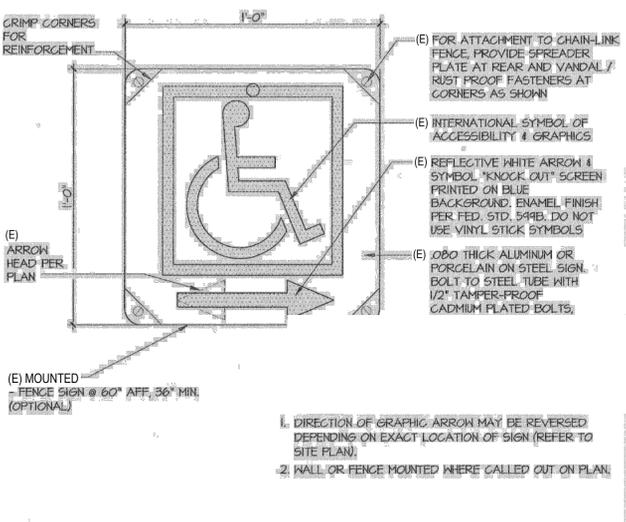


6 EXISTING DIRECTIONAL ACCESSIBILITY SIGN
SCALE: N.T.S. 9/A1.6 A#03-118276

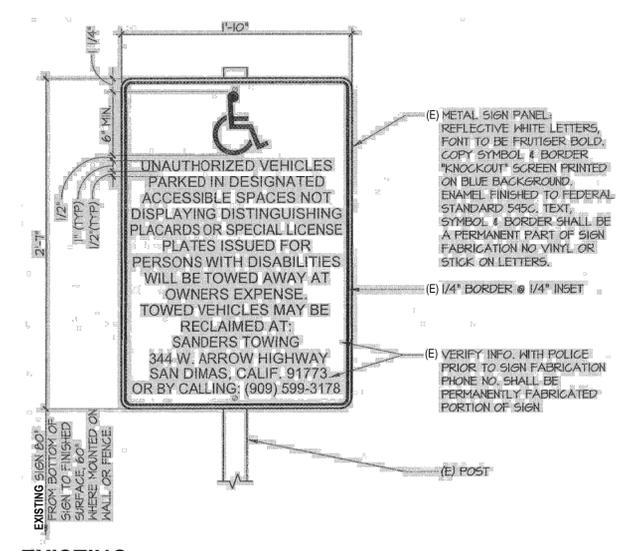


7 EXISTING TOW AWAY SIGN
SCALE: N.T.S. 16/A1.6 A#03-118276

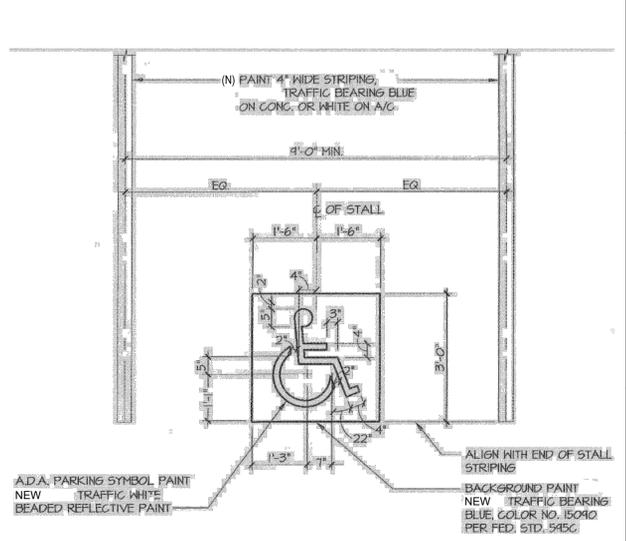


8 ACCESSIBLE PARKING SYMBOL
SCALE: N.T.S. 14/A1.6 A#03-118276

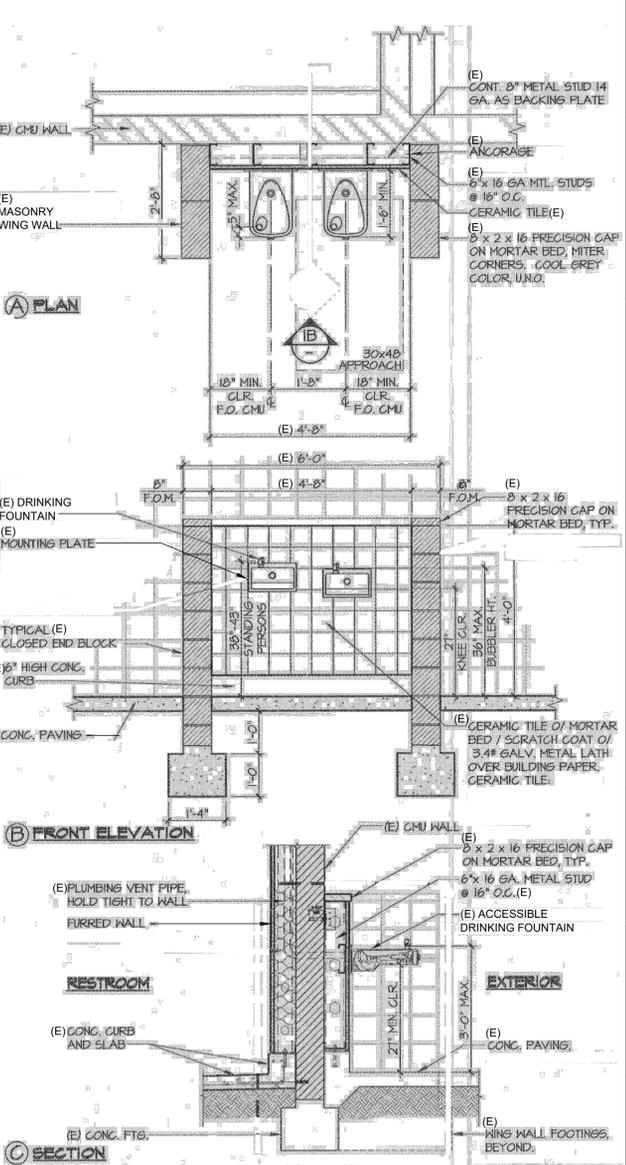


9 (E) ACCES. D.F. @ (E) TOILET BLDG.
SCALE: N.T.S. 1/A7.1 A#03-118276

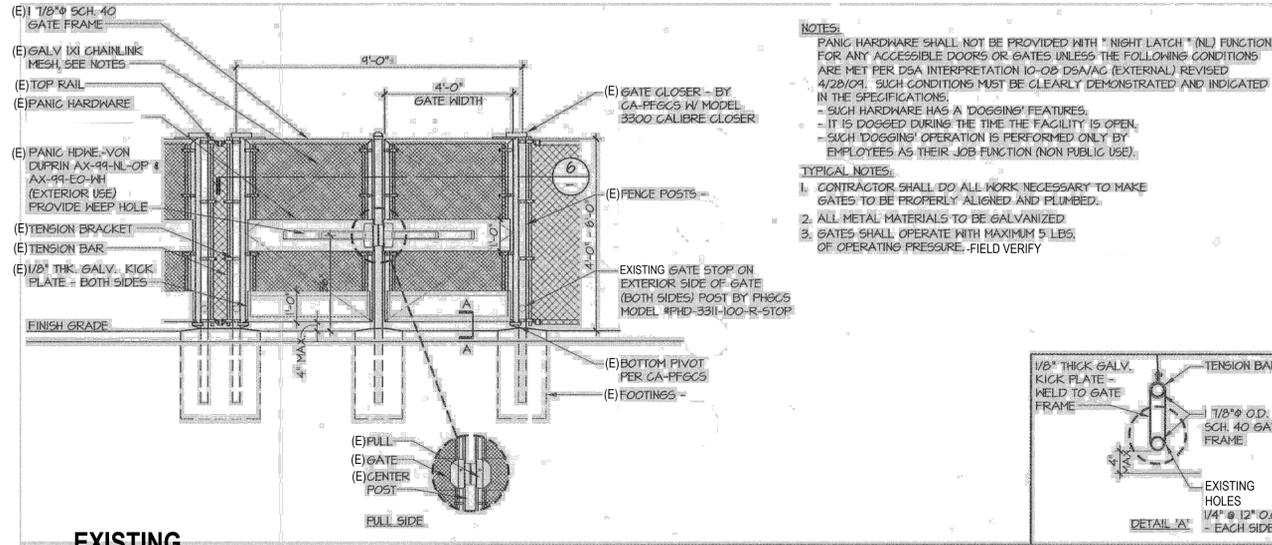


1 EXISTING DOUBLE CHAINLINK FENCE W/ PANIC HARDWARE
SCALE: N.T.S. 1/AS1.5 A# 03-118276

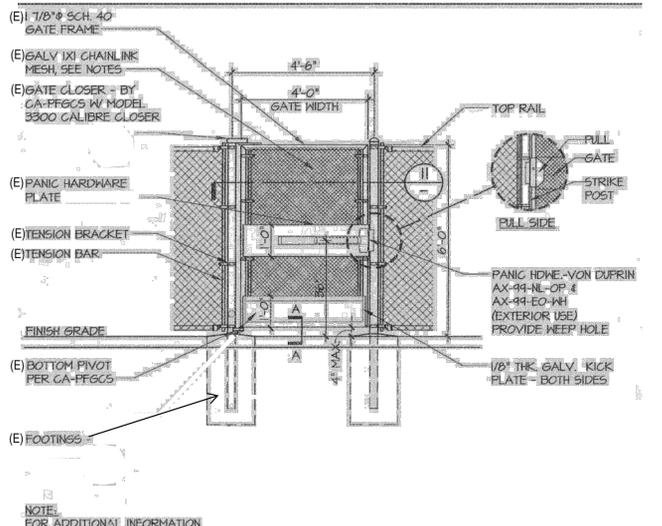


2 EXISTING CHAINLINK FENCE W/ PANIC HARDWARE
SCALE: N.T.S. 2/AS1.5 A# 03-118276

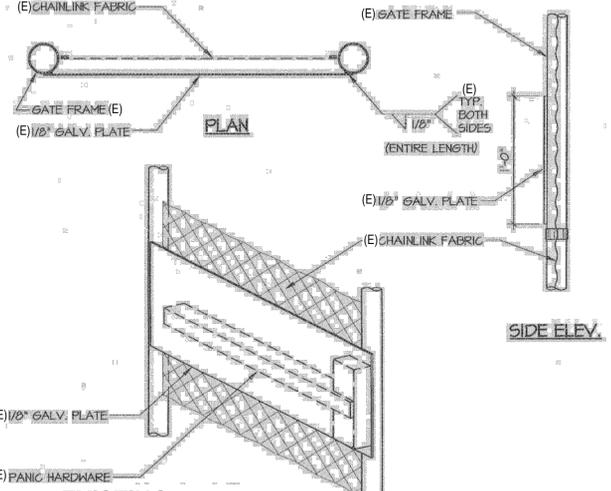


3 EXISTING PANIC HARDWARE PLATE @ CHAINLINK FENCE GATE
SCALE: N.T.S. 3/AS1.5 A# 03-118276

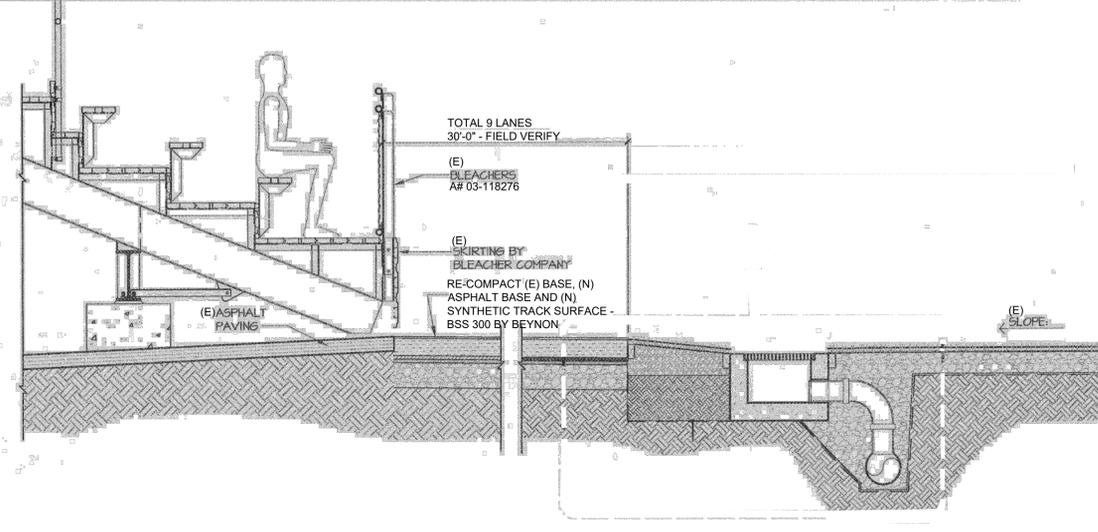


5 SECTION THRU STADIUM FIELD - NEW
SCALE: N.T.S.

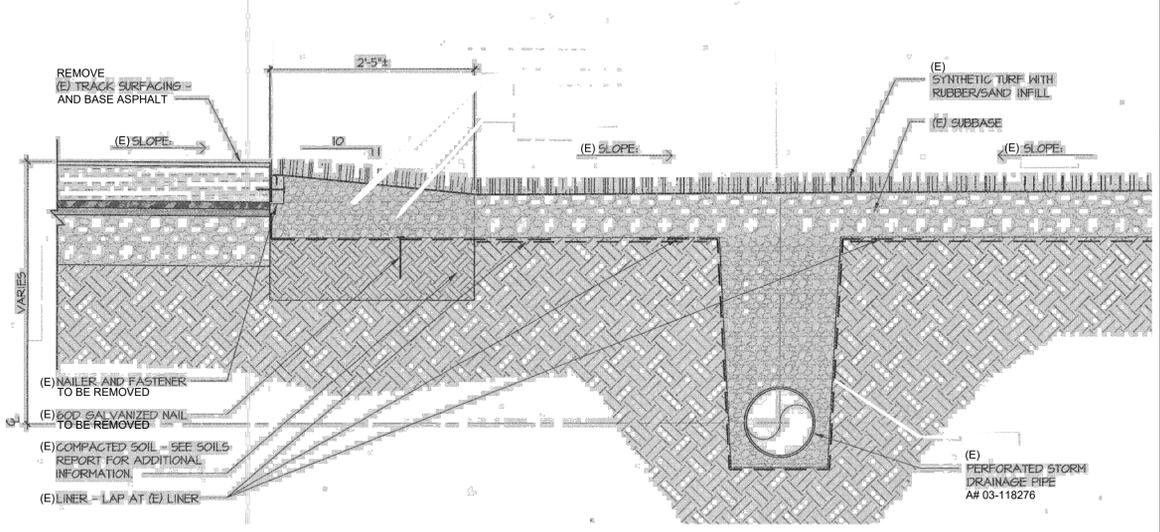

6 SYNTHETIC TURF DETAIL @ STADIUM FIELD/TRACK TRANSITION - DEMOLITION
SCALE: N.T.S.

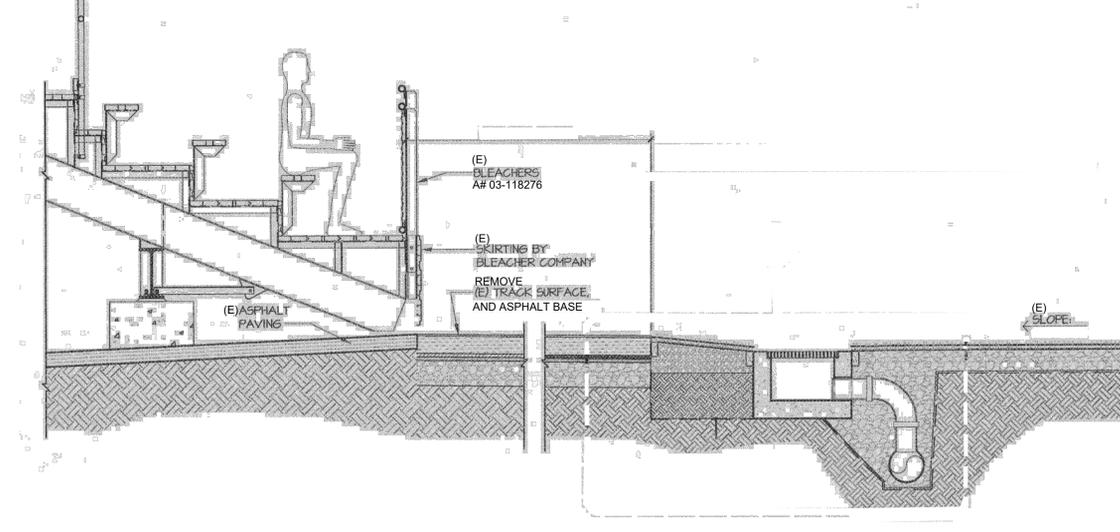

4 SECTION THRU STADIUM FIELD - DEMOLITION
SCALE: N.T.S. 1/AS1.7 A# 03-118276

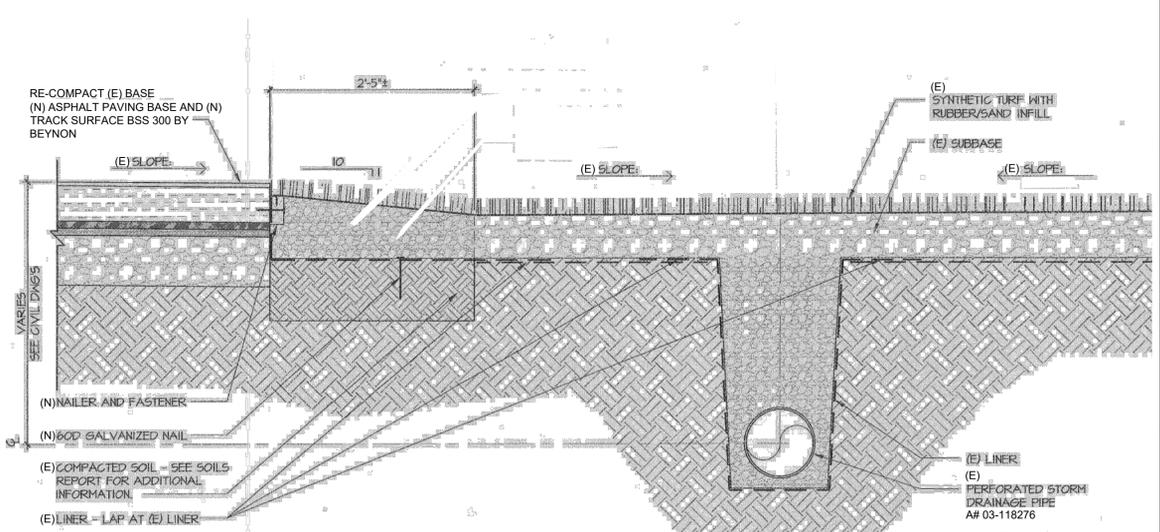

7 SYNTHETIC TURF DETAIL @ STADIUM FIELD/TRACK TRANSITION - NEW
SCALE: N.T.S.

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Architecture PLLLP
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8816 Foothill Boulevard, Suite 103-224
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a9contact@architecture9.com



ARCHITECTS STAMP:
CONSULTANT:
CONSULTANTS STAMP:

SCHOOL DISTRICT:
BONITA UNIFIED SCHOOL DISTRICT

PROJECT:
BONITA HIGH SCHOOL RUNNING TRACK REPLACEMENT
BONITA HIGH SCHOOL
3102 D. STREET
LAVERNE, CA. 91750

JOB NUMBER: 12.01.06
DATE: 3/12/25
REVISION: Δ DATE: _____
REVISION: Δ DATE: _____

DRAWING TITLE:
SITE DETAILS

DRAWING NO.:
A1.5

Exhibit A - Drawings

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LAVERNE, CA. 91750


JOB NUMBER: 12.01.06
DATE: 3/12/25

REVISION: Δ DATE: _____
REVISION: Δ DATE: _____

DRAWING TITLE:
SITE DETAILS


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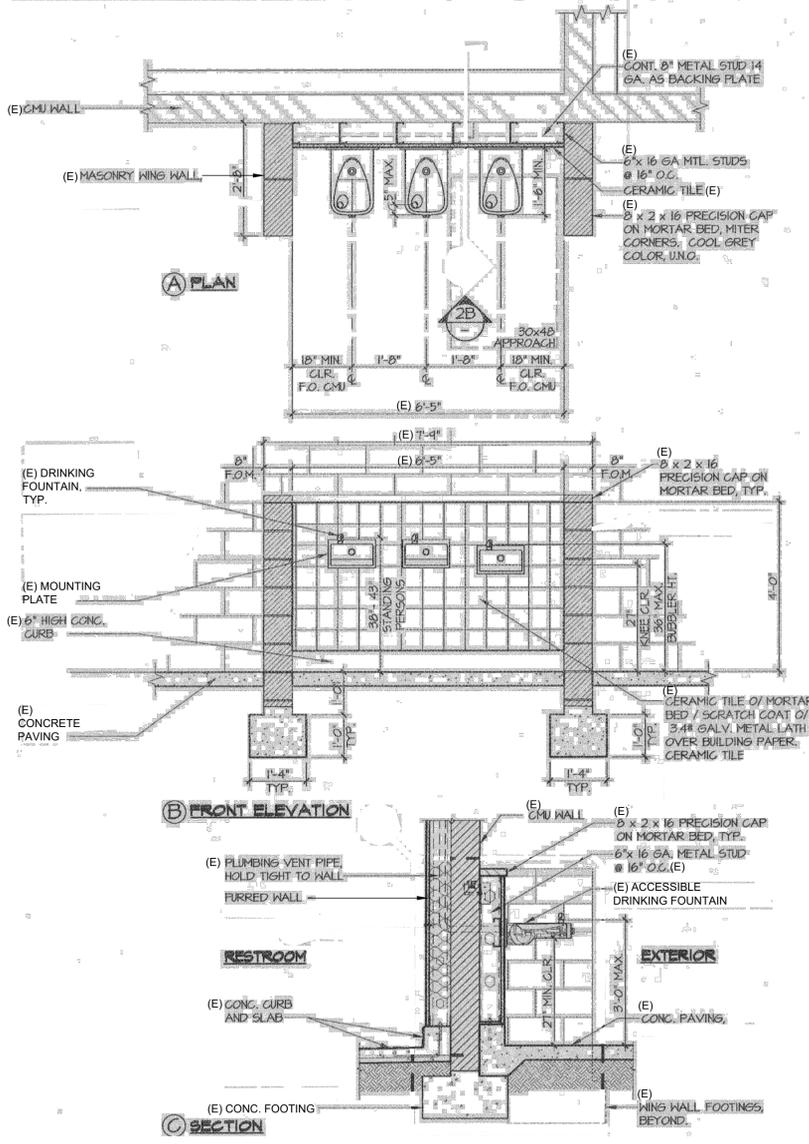


- KEYNOTES:**
- 1 4" THICK CONCRETE RAMP - EXISTING BROOM FINISH
 - 2 4" CONC. SLAB - EXISTING FISH PERPENDICULAR TO THE DIRECTION OF PATH
 - 3 6" WIDE X 6" HIGH CONCRETE CURB - EXISTING
 - 4 1 1/4" DIA. EXTRA STRONG GULP PIPE RAILING - EXISTING
 - 5 NOT USED
 - 6 6" HIGH CHAINLINK FENCING - EXISTING
 - 7 NOT USED
 - 8 EXISTING BLEACHERS W/ ACCESSIBLE RAMPS A# 03-118276
 - 9 EXISTING ACCESSIBLE PEDESTRIAN GATES RE: 1A1.5 AND 2A1.5
 - 10 EXISTING TRUNCATED DORIES RE: 3A1.4
 - 11 5" WIDE STRIPING FOR ACCESSIBLE PATH - EXISTING
 - 12 (E) STRUCTURE
 - 13 (E) FIELD LIGHT TO REPAIR, PROTECT IN PLACE
 - 14 (E) CONCRETE PAVING
 - 15 (E) AG PAVING
 - 16 (E) CHAINLINK FENCING TO REPAIR
 - 17 (E) VEGETATION AND TURF/DIRT
 - 18 (E) TREE - PROTECT IN PLACE
 - 19 (E) CONCRETE STEPS TO REPAIR
 - 20 (E) CONCRETE RAMP TO REPAIR
 - 21 (E) TENNIS COURTS
 - 21.1 - CONTROL JOINT
 - 21.2 - EXPANSION JOINT

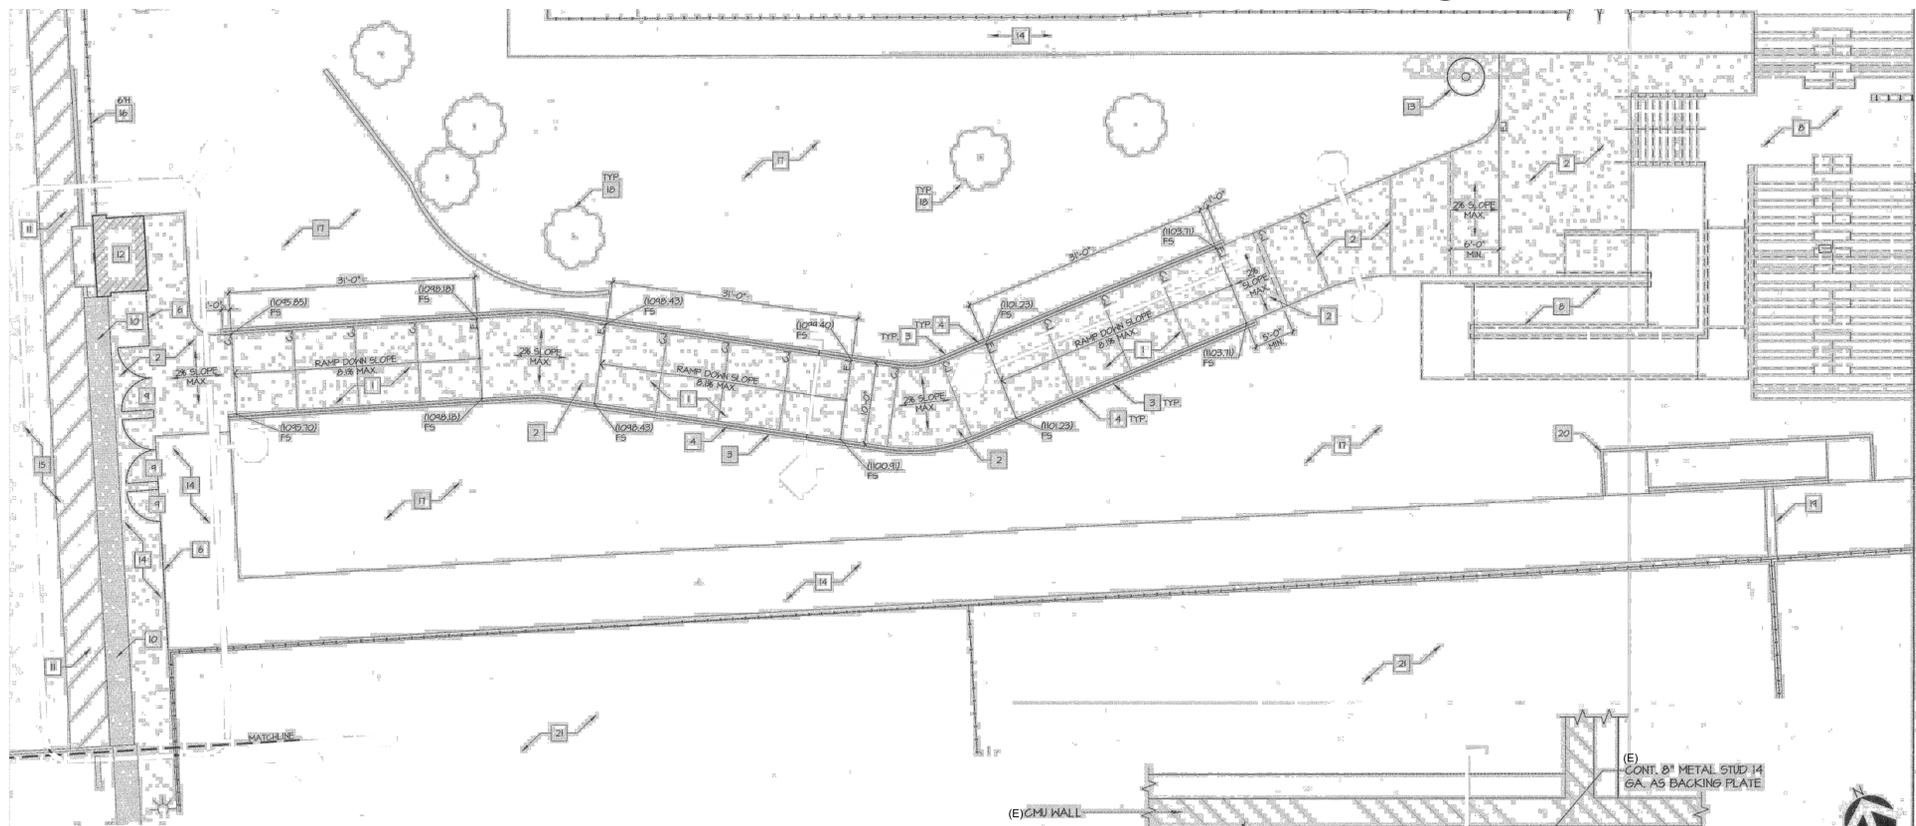1 EXISTING ENLARGED SITE PLAN @ HOME ENTRANCE
SCALE: N.T.S. 1/AS1.9 A# 03-118276 NORTH




2 EXISTING EXTERIOR RAMP/STAIR PLAN @ VISITOR ENTRANCE
SCALE: N.T.S. 5/AS1.9 A# 03-118276

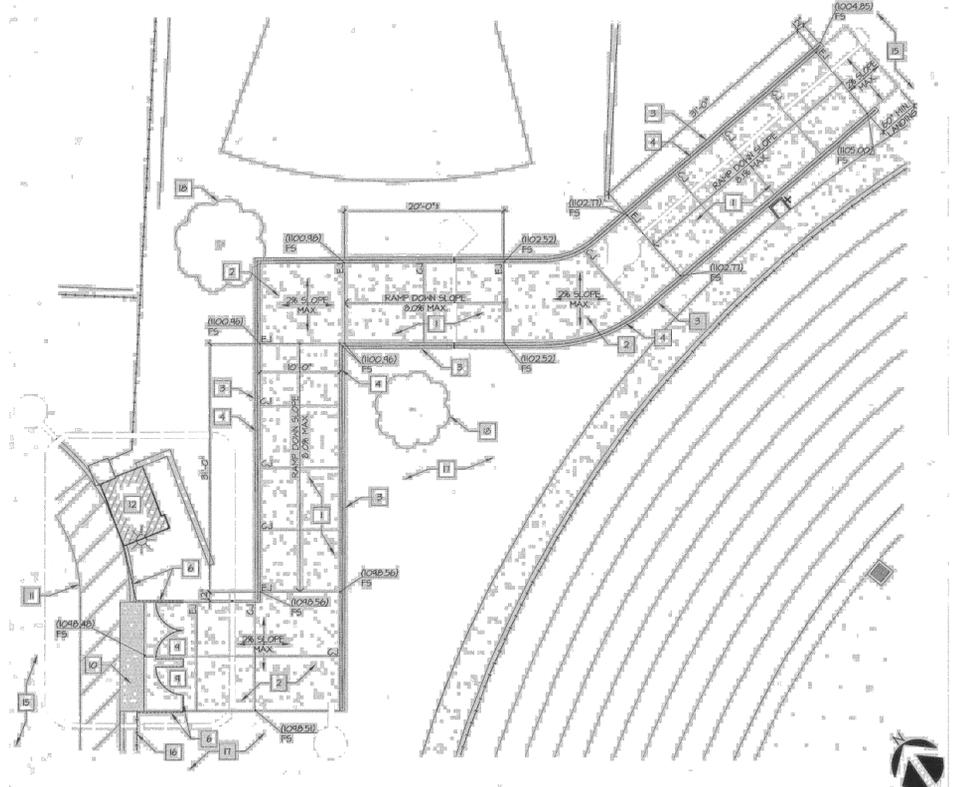


3 (E) ACCESS. D.F. @ (E) TOILET BLDG.
SCALE: N.T.S. 2/A1.1 A# 03-118276


Exhibit A - Drawings

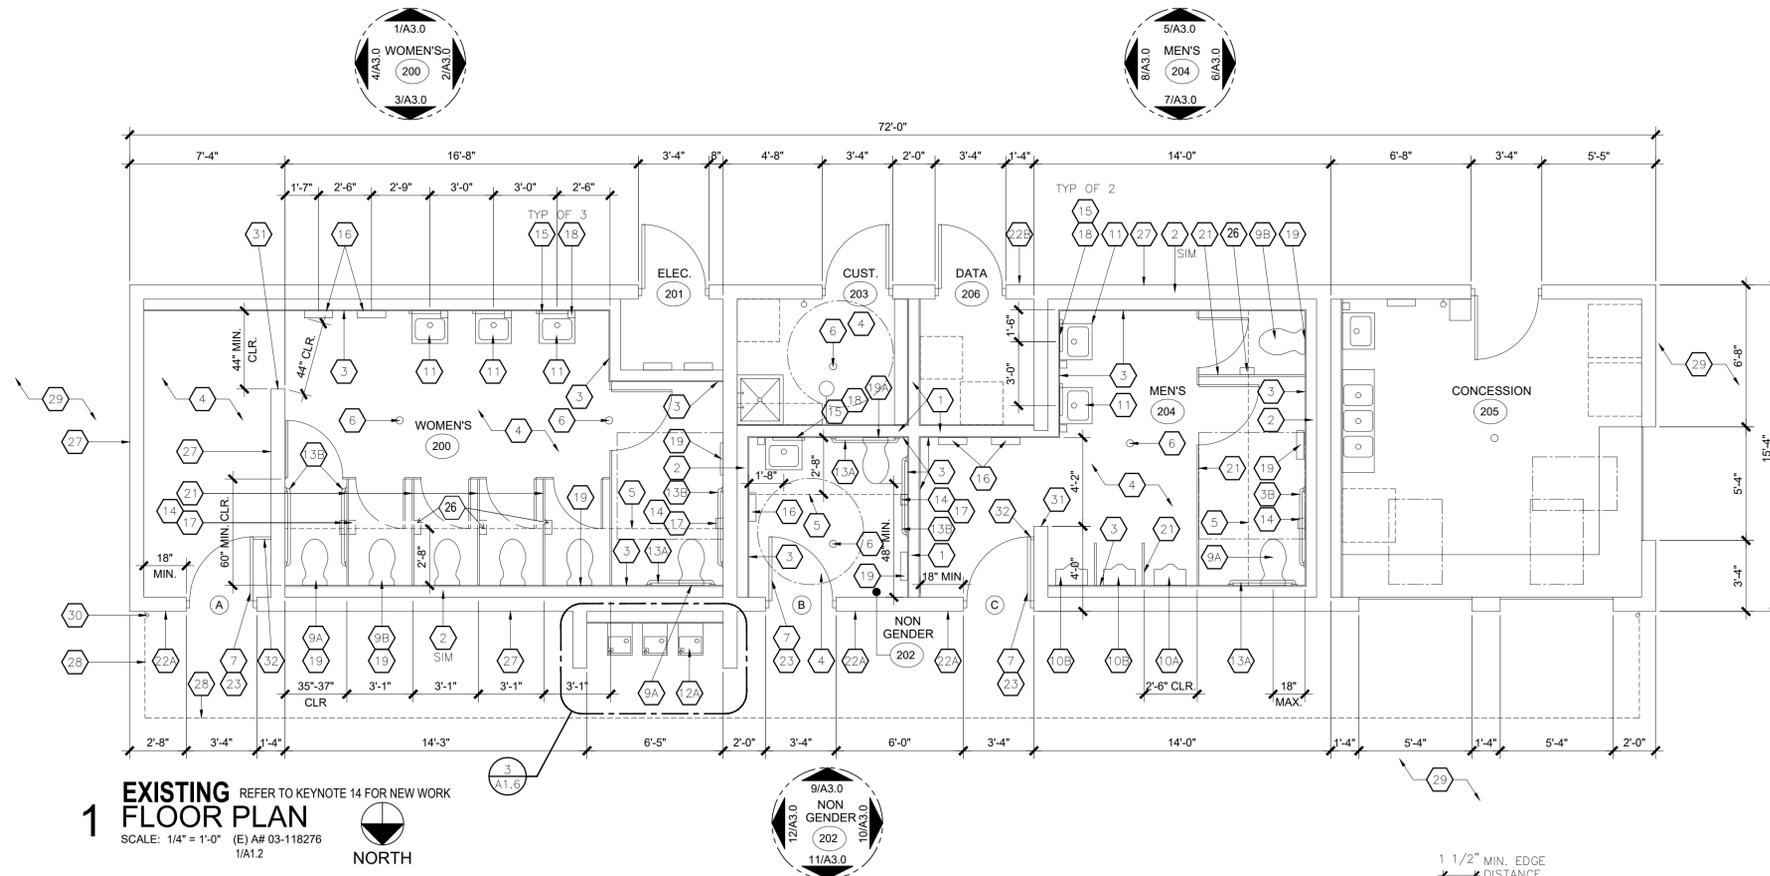


1 EXISTING FLOOR PLAN
 SCALE: 1/4" = 1'-0" (E) A# 03-118276
 1/A1.2

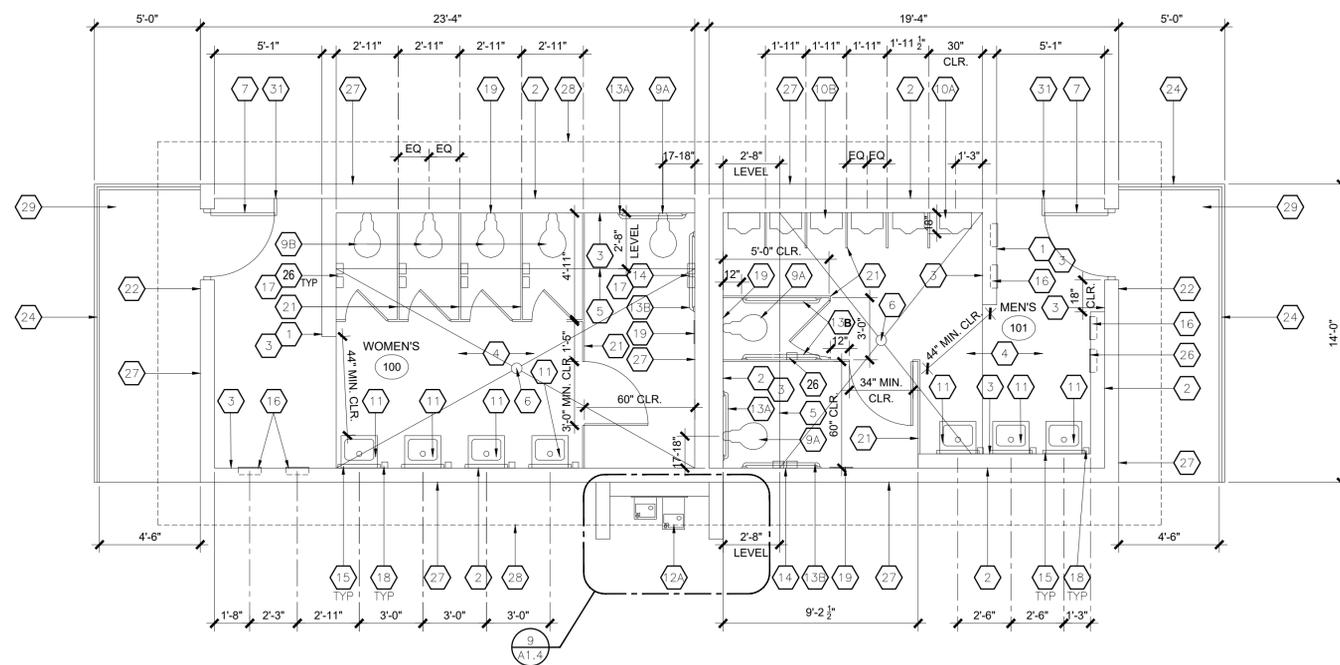

2 EXISTING FLOOR PLAN
 SCALE: 1/4" = 1'-0" (E) A# 03-118276
 1/A1.1

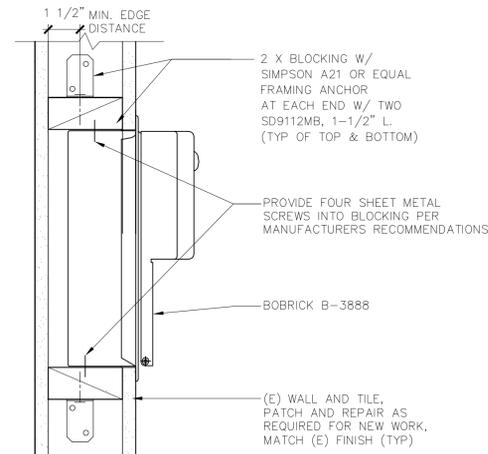

STUD MOUNTED

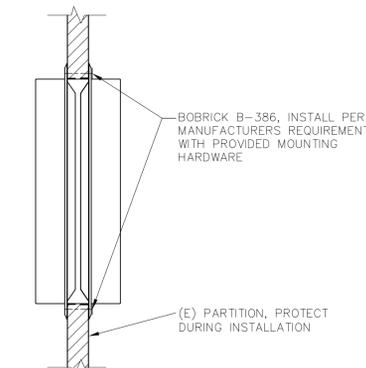

3 TOILET PAPER DETAILS
 SCALE: 3" = 1'-0"

KEYNOTES

1. (E) 6" 20 GA. METAL STUD FRAMED WALL ON 6" HIGH CONC. CURB
2. (E) 6" 20 GA. METAL STUD FLURRED WALL ON 6" HIGH CONC. CURB
3. (E) CERAMIC TILE WAINSCOT
4. (E) CONC. FLOOR SLAB W/ SMOOTH FINISH, HARDENER AND EPOXY SEALER WITH A COEFFICIENT OF FRICTION OF AT LEAST 0.42 (DCOF) PER ANSI A137.1
5. (E) LEVEL AREA FOR WATER CLOSET
6. (E) FLOOR DRAIN W/ 2% MAX SLOPE TO GRATE W/ 1/2" MAX. OPENING
7. (E) DOOR
8. (E) WALL MOUNTED FIRE EXTINGUISHER TYP., MOUNTED AT 48" A.F.F. TO HANDLE
- 9A. (E) ACCESSIBLE WATER CLOSET
- 9B. (E) STANDARD WATER CLOSET
- 10A. (E) ACCESSIBLE URINAL
- 10B. (E) STANDARD URINAL
11. (E) ACCESSIBLE LAVATORY W/ INSULATED PIPE JACKET
- 12A. (E) ACCESSIBLE DRINKING FOUNTAIN
- 12B. (E) FLOOR MOUNTED MOP SINK
- 12C. (E) EYEWASH STATION
- 12D. (E) WATER HEATER
- 13A. (E) 36" LONG GRAB BAR
- 13B. (E) 48" LONG GRAB BAR
14. (N) TOILET PAPER DISPENSER, RE: 3/A2.0
15. (E) FRAMELESS 18" X 30" S.S. MIRROR
16. (E) SURFACE MOUNTED HAND DRYER
17. (E) SANITARY NAPKIN DISPOSAL
18. (E) SURFACE MOUNTED SOAP DISPENSER
19. (E) SURFACE MOUNTED TOILET SEAT COVER DISPENSER
20. (E) SINGLE COLUMN 6 DOOR LOCKER
21. (E) TOILET PARTITION
- 22A. (E) RESTROOM NAME SIGNAGE, RE: A6.0
- 22B. (E) ROOM NAME & NAME PLAQUE W/ ACCESSIBILITY SYMBOL (U.N.O.)
23. (E) DOOR ACCESSIBILITY SIGNAGE, RE: A6.0
24. (E) CASEWORK
25. (E) 36" W. X 8" D. METAL UTILITY SHELF W/ MOP HANGER
26. (E) TOILET PAPER DISPENSER
27. (E) 8" CMU WALL
28. (E) LINE OF ROOF ABOVE
29. (E) CONCRETE WALKWAY / PAVING
30. (E) DOWNSPOUTS
31. (E) CLOSER END BLOCK AT EXPOSED EDGES
32. (E) GATE LOCK IN OPEN POSITION BAR, NOT TO EXCEED 3" PROTECTION

NOTE:
 RE: A6.0 FOR DOOR HARDWARE AND SIGNAGE

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 a9contact@architecture9.com

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PROJECT:
BONITA HIGH SCHOOL RUNNING TRACK REPLACEMENT

BONITA HIGH SCHOOL
 3102 D. STREET
 LAVERNE, CA. 91750

JOB NUMBER: 12.01.06
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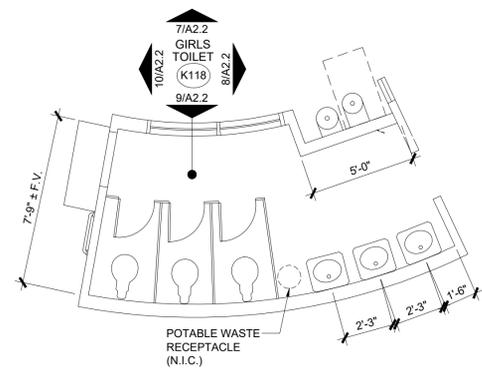
REVISION: 1 DATE: _____
 REVISION: 2 DATE: _____

DRAWING TITLE:
FLOOR PLAN


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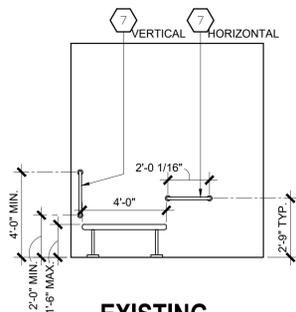
Exhibit A - Drawings




1 EXISTING ENLARGED FLOOR PLAN
SCALE: 1/4" = 1'-0"
A4/A303 A# 03-107966




2 EXISTING ENLARGED FLOOR PLAN ACCESSIBLE SHOWER & WHEEL CHAIR LIFT
SCALE: 1/4" = 1'-0"
A6/A305 A# 03-107966

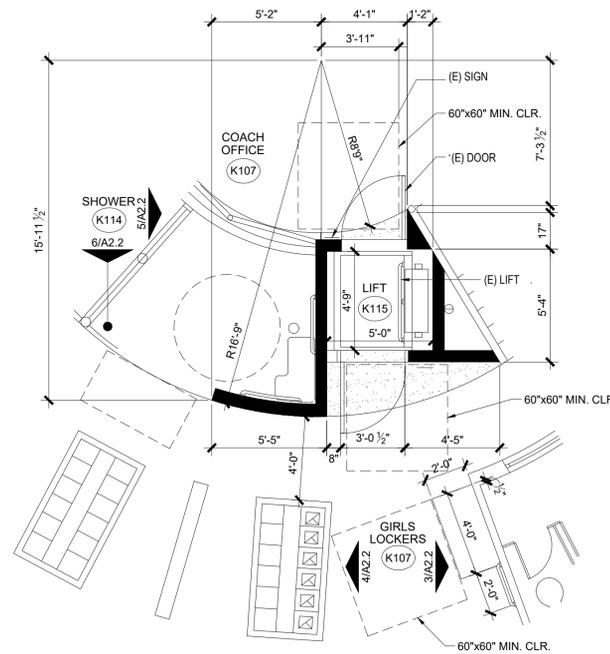


3 EXISTING ELEVATIONS
SCALE: 1/4" = 1'-0"
A# 03-107966 R12/A305

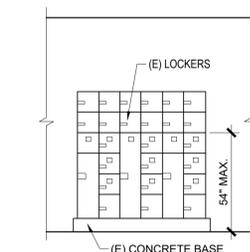


4 EXISTING ELEVATIONS
SCALE: 1/4" = 1'-0"
A# 03-107966 R12/A305

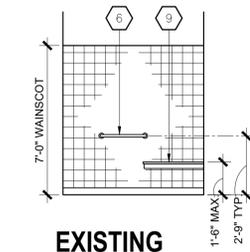


5 EXISTING ELEVATIONS
SCALE: 1/4" = 1'-0"
A# 03-107966 H19/A303

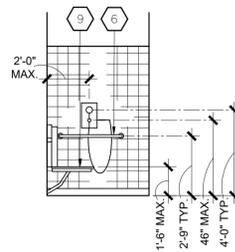


6 EXISTING ELEVATION
SCALE: 1/4" = 1'-0"
A# 03-107966 H19/A303

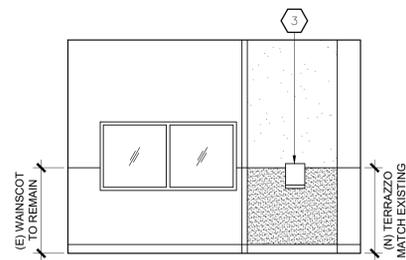


7 EXISTING ELEVATIONS
SCALE: 1/4" = 1'-0"
A# 03-107966 H4/A303

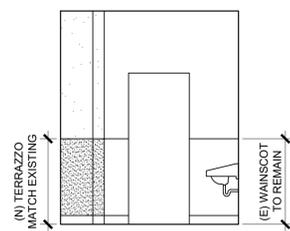

8 EXISTING ELEVATIONS
SCALE: 1/4" = 1'-0"
A# 03-107966 H4/A303

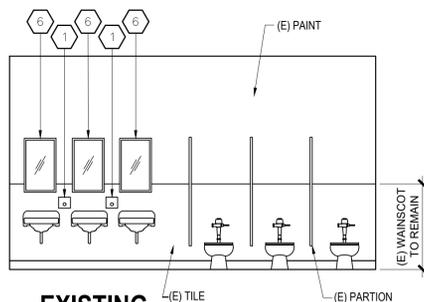

9 EXISTING ELEVATIONS
SCALE: 1/4" = 1'-0"
A# 03-107966 H4/A303

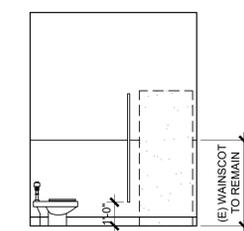

10 EXISTING ELEVATIONS
SCALE: 1/4" = 1'-0"
A# 03-107966 H4/A303

TOILET ACCESSORIES

- 1 (E) SOAP DISPENSER
- 2 (E) TOILET SEAT COVER DISPENSER, RECESSED
- 3 (E) PAPER TOWEL DISPENSER
- 4 (E) PAPER TOWEL DISPENSER/DISPOSAL UNIT
- 5 (E) TOILET PAPER DISPENSER
- 5a (E) D.P. RECESSED TOILET PAPER DISPENSER (MAX. 3" PROTRUSION FROM WALL, NON-CONTROLLED DELIVERY)
- 6 (E) MIRROR (STAINLESS STEEL 17 1/2" X 29 1/2")
- 7 (E) GRAB BAR
- 8 (E) NAPKIN DISPENSER (RECESSED)
- 9 (E) NAPKIN DISPOSAL UNIT
- 10 (E) ELECTRIC HANDDRYER
- 11 (E) ACCESSIBLE SEAT COVER

- NOTES:
1. ITEMS ARE SURFACE MOUNTED U.N.O.
 2. ITEMS SURFACE MOUNTED WHEN IT IS ATTACHED TO (E) O.N.U.WALLS

REFER TO A3.0A FOR MOUNTING HEIGHTS

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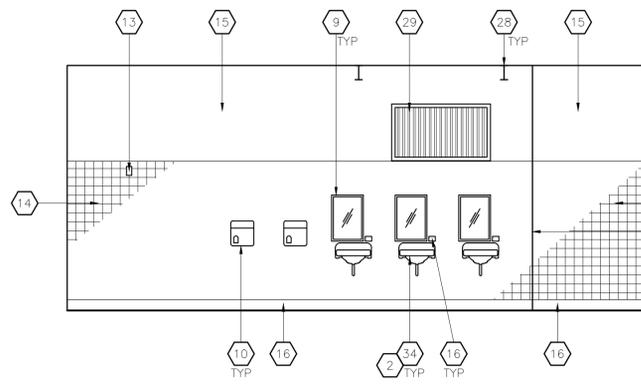
REVISION: 1 DATE: _____
REVISION: 2 DATE: _____

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ENLARGED FLOOR
PLANS AND
ELEV BLDG. K


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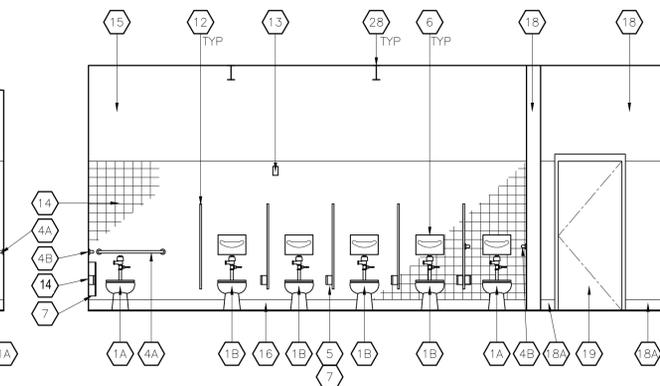
Exhibit A - Drawings




1 EXISTING INT. ELEV.
SCALE: 1/4" = 1'-0"
A# 03-118276 1/A6.2




2 EXISTING INT. ELEV. REFER TO KEYNOTE 14 FOR NEW WORK
SCALE: 1/4" = 1'-0"
A# 03-118276 1/A6.2

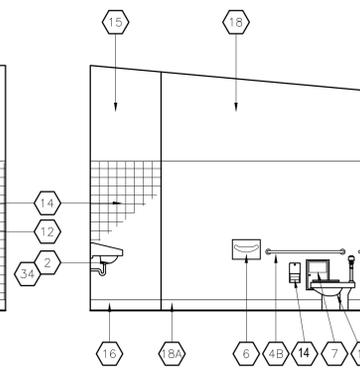


3 EXISTING INT. ELEV. REFER TO KEYNOTE 14 FOR NEW WORK
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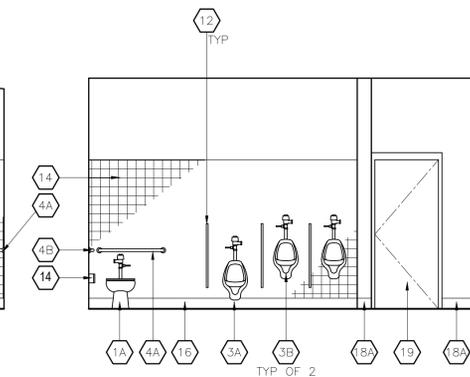
4 EXISTING INT. ELEV.
SCALE: 1/4" = 1'-0"
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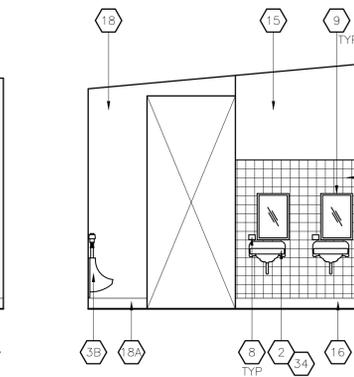
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A# 03-118276 2/A6.2

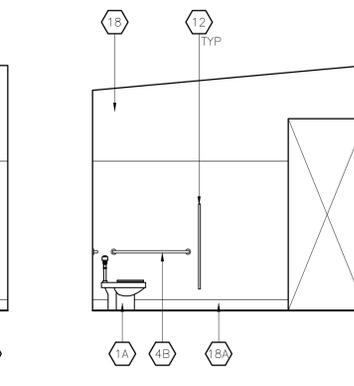


6 EXISTING INT. ELEV. REFER TO KEYNOTE 14 FOR NEW WORK
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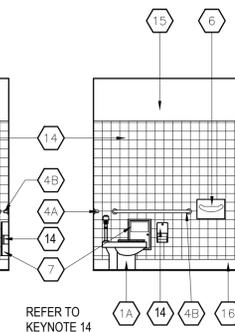
7 EXISTING INT. ELEV. REFER TO KEYNOTE 14 FOR NEW WORK
SCALE: 1/4" = 1'-0"
A# 03-118276 2/A6.2

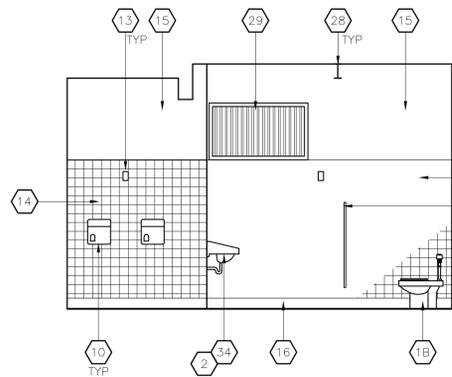


8 EXISTING INT. ELEV.
SCALE: 1/4" = 1'-0"
A# 03-118276 2/A6.2

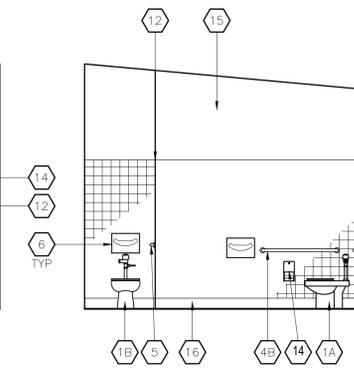


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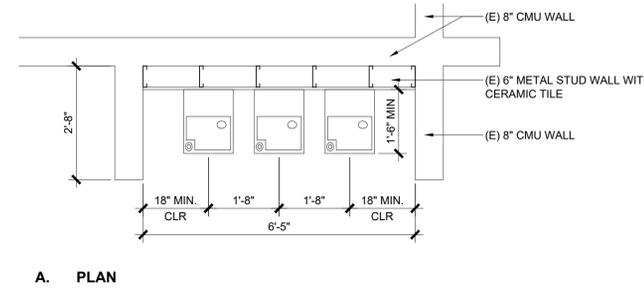
10 EXISTING INT. ELEV. REFER TO KEYNOTE 14 FOR NEW WORK
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A# 03-118276 3/A6.2

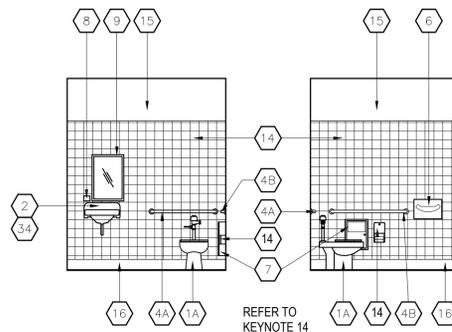


11 EXISTING INT. ELEV.
SCALE: 1/4" = 1'-0"
A# 03-118276 3/A6.2

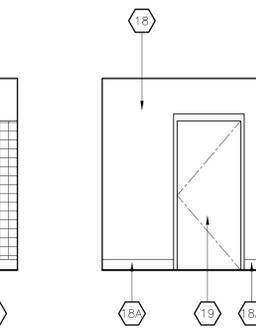

12 EXISTING INT. ELEV.
SCALE: 1/4" = 1'-0"
A# 03-118276 3/A6.2

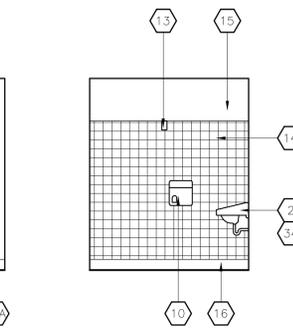

A. PLAN

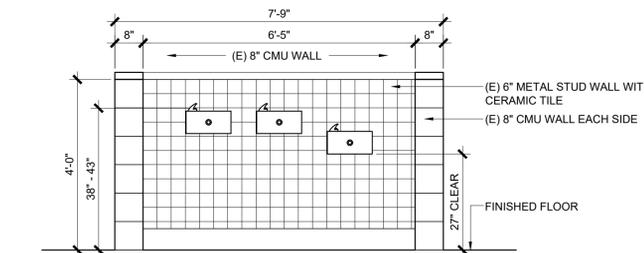

B. ELEVATION
13 EXISTING DRINKING FOUNTAIN
SCALE: 1/2" = 1'-0"
(E) A# 03-118276 2/A7.1

KEYNOTES

1. (E) 6" 20 GA. METAL STUD FRAMED WALL ON 6" HIGH CONC. CURB
2. (E) 6" 20 GA. METAL STUD FURRED WALL ON 6" HIGH CONC. CURB
3. (E) CERAMIC TILE WAINSCOT
4. (E) CONC. FLOOR SLAB W/ SMOOTH FINISH, HARDENER AND EPOXY SEALER WITH A COEFFICIENT OF FRICTION OF AT LEAST 0.42 (DCOF) PER ANSI A137.1
5. (E) LEVEL AREA FOR WATER CLOSET
6. (E) FLOOR DRAIN W/ 2% MAX SLOPE TO GRATE W/ 1/2" MAX. OPENING
7. (E) DOOR
8. (E) WALL MOUNTED FIRE EXTINGUISHER TYP., MOUNTED AT 48" A.F.F. TO HANDLE
- 9A. (E) ACCESSIBLE WATER CLOSET
- 9B. (E) STANDARD WATER CLOSET
- 10A. (E) ACCESSIBLE URINAL
- 10B. (E) STANDARD URINAL
11. (E) ACCESSIBLE LAVATORY W/ INSULATED PIPE JACKET
- 12A. (E) ACCESSIBLE DRINKING FOUNTAIN
- 12B. (E) FLOOR MOUNTED MOP SINK
- 12C. (E) EYEWASH STATION
- 12D. (E) WATER HEATER
- 13A. (E) 36" LONG GRAB BAR
- 13B. (E) 48" LONG GRAB BAR
14. (N) TOILET PAPER DISPENSER, RE. 3/4" 0
15. (E) FRAMELESS 18" X 30" S.S. MIRROR
16. (E) SURFACE MOUNTED HAND DRYER
17. (E) SANITARY NAPKIN DISPOSAL
18. (E) SURFACE MOUNTED SOAP DISPENSER
19. (E) SURFACE MOUNTED TOILET SEAT COVER DISPENSER
20. (E) SINGLE COLUMN 6 DOOR LOCKER
21. (E) TOILET PARTITION
- 22A. (E) RESTROOM NAME SIGNAGE
- 22B. (E) ROOM NAME & NAME PLAQUE W/ ACCESSIBILITY SYMBOL (U.N.O.)
23. (E) DOOR ACCESSIBILITY SIGNAGE
24. (E) CASEWORK
25. (E) 36" W. X 8" D. METAL UTILITY SHELF W/ MOP HANGER
26. NOT USED
27. (E) 8" CMU WALL
28. (E) LINE OF ROOF ABOVE
29. (E) CONCRETE WALKWAY / PAVING
30. (E) DOWNSPOUTS
31. (E) CLOSER END BLOCK AT EXPOSED EDGES
32. (E) GATE LOCK IN OPEN POSITION BAR, NOT TO EXCEED 3" PROTECTION
33. NOT USED
34. (E) ACCESSIBLE HAND SINK

REFER TO A3.0A FOR MOUNTING HEIGHTS



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a9contact@architecture9.com

ARCHITECTS STAMP:



CONSULTANT:

CONSULTANTS STAMP:

SCHOOL DISTRICT:
BONITA UNIFIED SCHOOL DISTRICT

PROJECT:
BONITA HIGH SCHOOL RUNNING TRACK REPLACEMENT

BONITA HIGH SCHOOL
3102 D. STREET
LAVERNE, CA. 91750

JOB NUMBER: 12.01.06
DATE: 3/12/25

REVISION: Δ DATE: _____
REVISION: Δ DATE: _____


DRAWING TITLE:
INTERIOR ELEVATIONS

DRAWING NO.:

A3.0

Exhibit A - Drawings

STANDARD FIXTURES HEIGHT DIMENSIONS	ADULT
1. TOILET SEAT HEIGHT / DIMENSIONS TO TOP OF SEAT	15"
2. TOILET PAPER IN FRONT OF TOILET	12"
3. NOT USED	
4. DISPENSER OR MIRROR HEIGHT	40"
5. LAVATORY / SINK TOP HEIGHT	34"
6. URINAL LIP HEIGHT	24"
7. URINAL FLUSH HANDLE HEIGHT	44"
8. TOILET PAPER DISPENSER HEIGHT	30"
9. DRINKING FOUNTAIN BUBBLER HEIGHT	39" - 42"

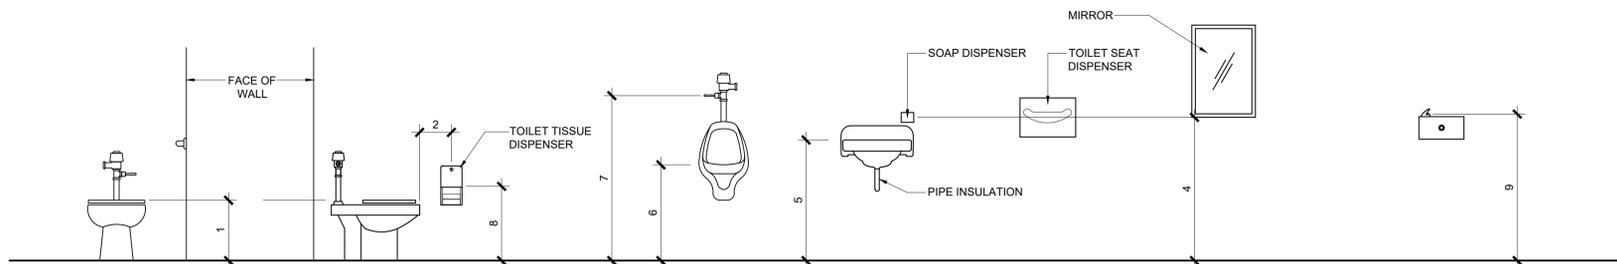


1 MOUNTING HEIGHTS

SCALE: 1/2" = 1'-0"
(E) A# 03-118276

STANDARD HEIGHT

ACCESSIBLE FIXTURES HEIGHT DIMENSIONS	ADULT
A. TOILET CENTERING FROM WALL	17"-18"
B. TOILET SEAT HEIGHT TO TOP OF SEAT	17"-19"
C. GRAB BAR HEIGHT	33"-36"
D. TOILET PAPER ABOVE FLOOR	19"
E. TOILET PAPER IN FRONT OF TOILET	7"-9"
F. NAPKIN DISPOSAL IN FRONT OF TOILET	12" MAX.
G. DISPENSER HEIGHT	40" MAX.
H. MIRROR HEIGHT (BOTTOM OF REFLECTIVE SURFACE)	40" MAX. 35" MAX NOT OVER LAV
I. LAVATORY/SINK TOP HEIGHT	34" MAX.
J. LAVATORY APRON CLEARANCE	29" MIN.
K. LAVATORY/SINK KNEE CLEARANCE	27" MIN.
L. URINAL LIP HEIGHT	17" MAX.
M. URINAL TOILET FLUSH HANDLE HEIGHT	44" MAX.
N. DRINKING FOUNTAIN BUBBLER HEIGHT	27" MIN.
O. DRINKING FOUNTAIN KNEE CLEARANCE	27" MIN.
P. HAND DRYER	40" MAX.

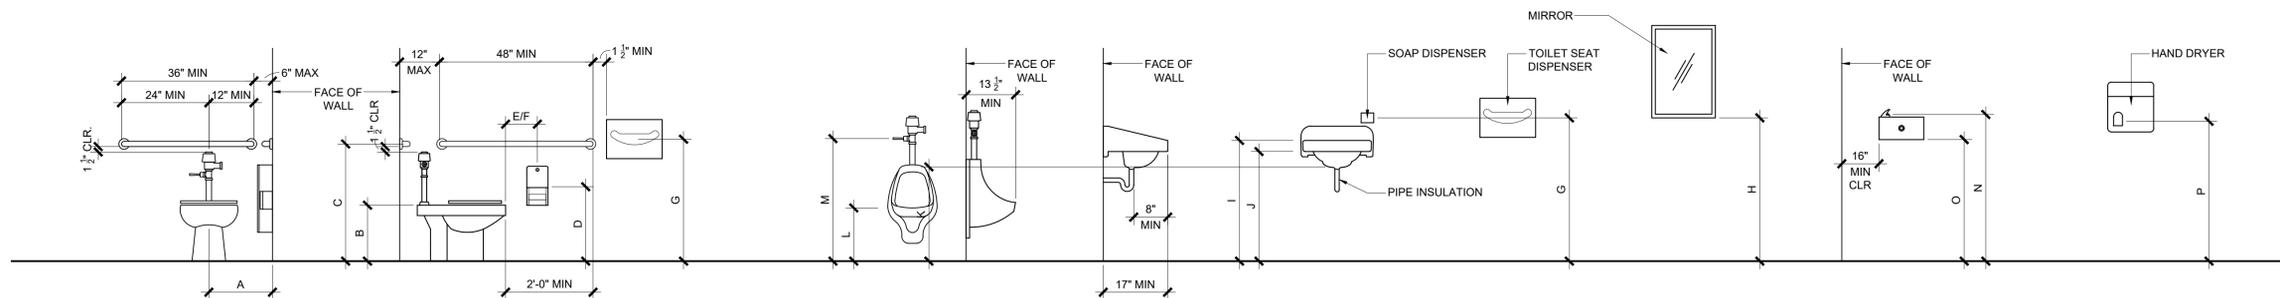

2 MOUNTING HEIGHTS

SCALE: 1/2" = 1'-0"
(E) A# 03-118276

ACCESSIBLE HEIGHT

IDENTIFICATION STAMP
DIV. OF THE STATE ARCHITECT
APP: 03-125353 INC:
REVIEWED FOR
SS FLS ACS
DATE: 01/29/2026

Architecture
9 PLLLP

8816 Foothill Boulevard, Suite 103-224
Rancho Cucamonga, CA. 91730
a9contact@architecture9.com

ARCHITECTS STAMP:



CONSULTANT:

CONSULTANTS STAMP:

SCHOOL DISTRICT:

BONITA UNIFIED
SCHOOL DISTRICT

PROJECT:

BONITA
HIGH SCHOOL
RUNNING TRACK
REPLACEMENT

BONITA HIGH SCHOOL
3102 D. STREET
LAVERNE, CA. 91750

JOB NUMBER: 12.01.06
DATE: 3/12/25

REVISION: 1 DATE: _____
REVISION: 2 DATE: _____

DRAWING TITLE:
MOUNTING
HEIGHTS

DRAWING NO.:



A3.0A

Exhibit A - Drawings

DOOR AND SIGNAGE SCHEDULE

ROOM TYPE	DOOR TYPE										FRAME TYPE						SIGNAGE		LEGEND						
	MARK NO	DOOR TYPE	INTERIOR	EXTERIOR	WOOD	WIRE MESH	HOLLOW METAL	SINGLE	PAIR	WIDTH	HEIGHT	HARDWARE SET	PANIC HARDWARE	GLAZING TYPE	DOOR AND FRAME LABEL (MIN)	FRAME TYPE	WOOD	HOLLOW METAL		ALUMINUM	HEAD	JAMB	SILL	EXTERIOR SIDE	INTERIOR SIDE
WOMEN'S TOILET	A	B	-	○	-	○	-	-	3'-0"	7'-0"	1	-	-	-	-	-	-	-	-	-	-	-	3/A6.0	3/A6.0	
NON-GENDER TOILET	B	B	-	○	-	○	-	-	3'-0"	7'-0"	1	-	-	20	-	-	-	-	-	-	-	-	8/A6.0	3/A6.0	
MEN'S TOILET	C	B	-	○	-	○	-	-	3'-0"	7'-0"	1	-	-	60	-	-	-	-	-	-	-	-	3/A6.0	3/A6.0	

HARDWARE TYPE 1:
 STAFF TOILETS:
 LOCK L9 456 TO GN L583-363-L238-722
 CORE Z3-030 EV 29T
 LEVER SCGLAGE L-SERIES MODEL 06 BOTH SIDES OF DOOR

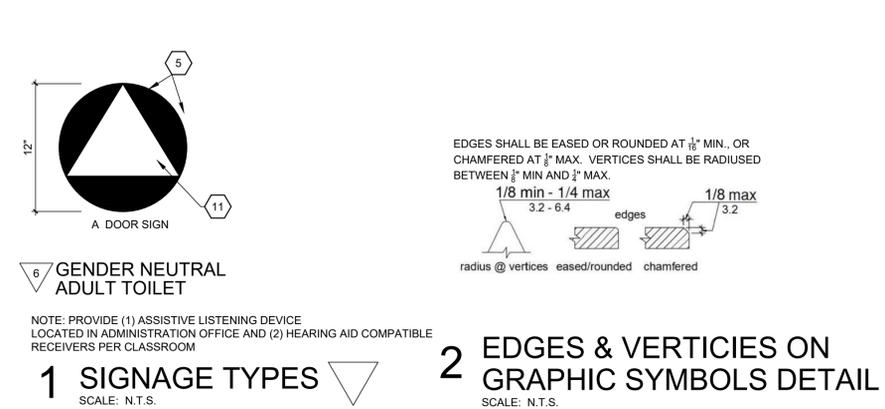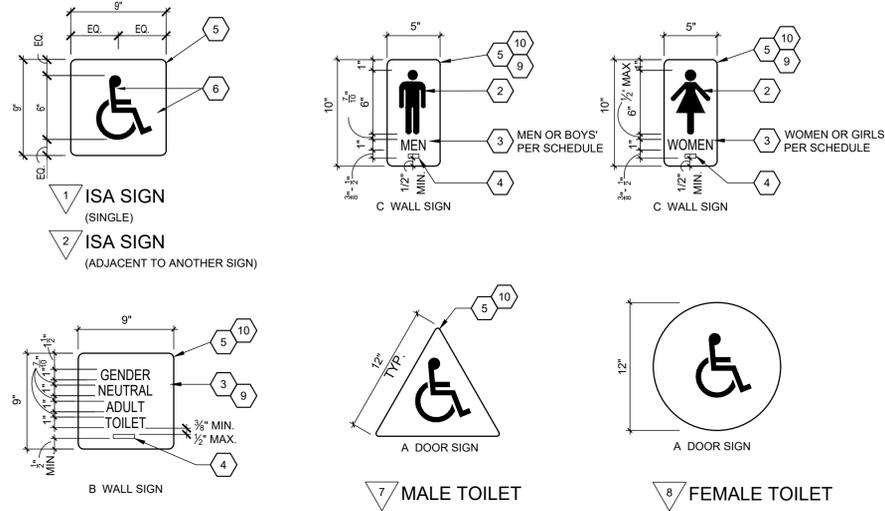


1 SIGNAGE TYPES

- NOTE: PROVIDE (1) ASSISTIVE LISTENING DEVICE LOCATED IN ADMINISTRATION OFFICE AND (2) HEARING AID COMPATIBLE RECEIVERS PER CLASSROOM
- RAISED WHITE ROOM TEXT OR NUMBER, 5/8 INCH TO 4 INCH HIGH & RAISED 1/32 INCH MINIMUM
 - RAISED PICTORIAL SYMBOL, 6" HIGH MIN & RAISED 1/32 INCH MINIMUM
 - RAISED TEXT, RAISED 1/32 INCH MINIMUM. TEXT TO MATCH FLOOR PLAN
 - CALIFORNIA BRAILLE, CONTRACTED GRADE 2. REFER TO TABLE IIB-703.3.1
 - RADIUS CORNER TYPICAL, 1/8" MIN. AND 1/4" MAX. RE: 2/A4.1
 - 6" HIGH INTERNATIONAL SYMBOL OF ACCESSIBILITY (ISA) SYMBOL TO BE WHITE, BACKGROUND TO BE COLOR #15090 IN FEDERAL STANDARD 595C. ITS PROPORTIONS SHALL BE PER CBC FIGURE 11B-703.7.2.1. COMPLY WITH CBC 11B-216.8 & 11B-703.2.1
 - INTERNATIONAL SYMBOL OF ACCESS FOR HEARING LOSS SYMBOL, COMPLY WITH CBC 11B-703.7.2.4
 - BACKGROUND TO BE COLOR RED
 - BACKGROUND TO BE SELECTED BY ARCHITECT, WHERE LETTERING OR SYMBOLS OCCUR, TO BE WHITE
 - EDGES SHALL BE EASED OR ROUNDED AT 1/16" MIN. OR CHAMFERED AT 1/8" MIN.
 - CONTRASTING COLOR 1/4" THICK TRIANGLE ON 1/2" THICK CIRCLE WHICH IS CONTRASTING COLOR OF DOOR. EDGES AND VERTICES ON GEOMETRIC SYMBOLS SHALL BE EASY OR ROUNDED AT 1/8" MINIMUM OR 1/4" MAX. VERTICES SHALL BE RADIUSSED BETWEEN 1/8" AND 1/4" LETTERING TO BE VISUAL (PER 11B-703.5) NOT RAISED

2 EDGES & VERTICES ON GRAPHIC SYMBOLS



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3 SIGNAGE PLAN

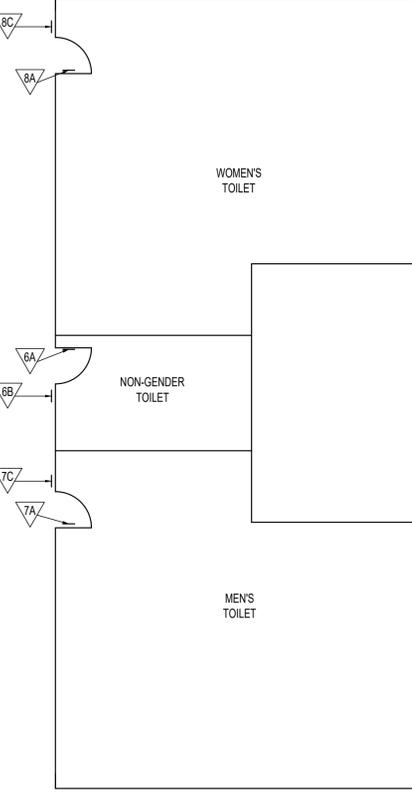
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MOUNTING DETAILS



6 DOOR SIGNAGE LOCATIONS


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GENERAL DOOR NOTES

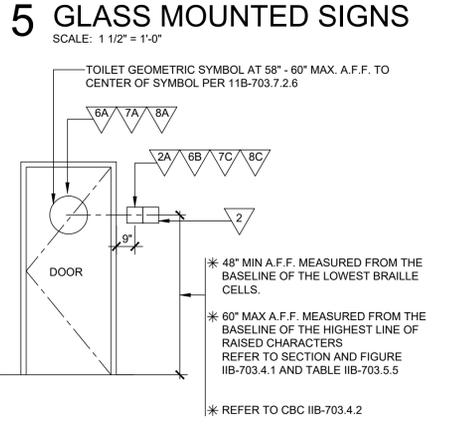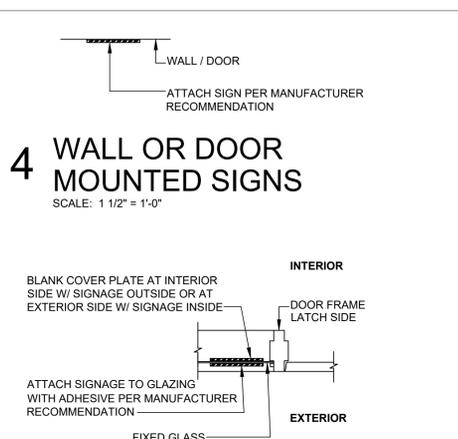
- MAXIMUM EFFORT TO OPERATE DOORS SHALL NOT EXCEED 5 POUNDS PER 2022 CBC FOR EXTERIOR AND INTERIOR DOORS. SUCH PULL OR PUSH EFFORT BEING APPLIED AT RIGHT ANGLES TO HINGED DOORS AT CENTER PLANE OF SLIDING OR FOLDING DOORS. COMPENSATING DEVICES OR AUTOMATIC DOOR OPERATORS MAY BE UTILIZED TO MEET THE ABOVE STANDARDS. THE AUTHORITY HAVING JURISDICTION MAY INCREASE THE MAXIMUM EFFORT TO OPERATE FIRE DOORS TO ACHIEVE POSITIVE LATCHING, BUT NOT EXCEED 15 POUNDS MAXIMUM. CBC 1133.
- EXIT DOORS SHALL BE OPENABLE AT ALL TIMES FROM THE INSIDE WITHOUT THE USE OF A KEY OR ANY SPECIAL KNOWLEDGE OR EFFORT.
- EMERGENCY EXIT AND PANIC HARDWARE:
 A. COMPLIANCE WITH SFM STANDARD 12-10-3, SECTION 12-10-302.
 B. THE CROSS-BAR SHALL EXTEND ACROSS NOT LESS THAN ONE-HALF THE WIDTH OF THE DOOR / GATE.

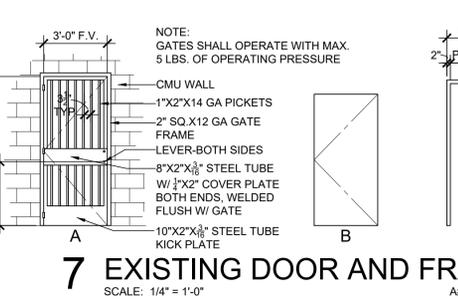NOT ON PUSH SIDE. SWING DOORS AND GATE SURFACES WITHIN 10" OF THE FINISH FLOOR OR GROUND SHALL HAVE A SMOOTH SURFACE ON THE PUSH SIDE EXTENDING THE FULL WIDTH OF THE DOOR GATE. PARTS CREATING HORIZONTAL OR VERTICAL JOINTS IN THESE SURFACES SHALL BE WITHIN 1/8" OF THE SAME PLANE AS THE OTHER AND BE FREE OF SHARP OR ABRASIVE EDGES. CAVITIES CREATED BY ADDED KICK PLATES SHALL BE CAPPED. CBC SECTION 11B-404.2.10



GENERAL DOOR NOTES

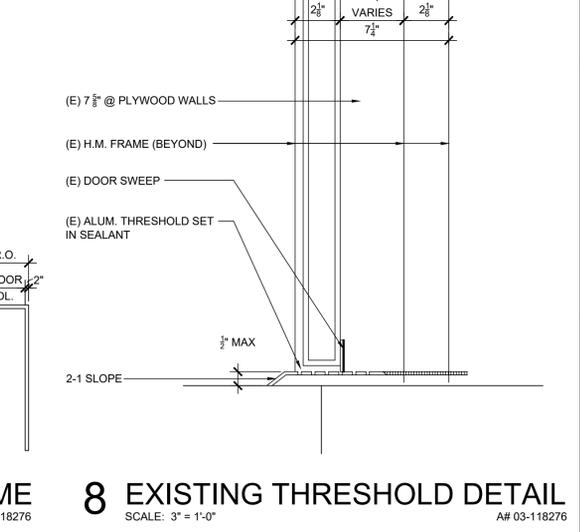PROJECT:
BONITA HIGH SCHOOL RUNNING TRACK REPLACEMENT
 BONITA HIGH SCHOOL
 3102 D. STREET
 LAVERNE, CA. 91750

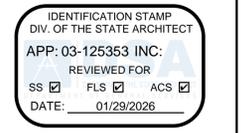

CONSULTANT:

CONSULTANTS STAMP:

SCHOOL DISTRICT:
BONITA UNIFIED SCHOOL DISTRICT

PROJECT:
BONITA HIGH SCHOOL RUNNING TRACK REPLACEMENT
 BONITA HIGH SCHOOL
 3102 D. STREET
 LAVERNE, CA. 91750

JOB NUMBER: 12.01.06
 DATE: 3/12/25
 REVISION: DATE:
 REVISION: DATE:

DRAWING TITLE:
SIGNAGE & DOOR SCHEDULE

DRAWING NO.:

A6.0

KEYNOTES

- RAISED WHITE ROOM TEXT OR NUMBER, 5/8 INCH TO 4 INCH HIGH & RAISED 1/32 INCH MINIMUM
- RAISED PICTORIAL SYMBOL, 6" HIGH MIN & RAISED 1/32 INCH MINIMUM
- RAISED TEXT, RAISED 1/32 INCH MINIMUM. TEXT TO MATCH FLOOR PLAN
- CALIFORNIA BRAILLE, CONTRACTED GRADE 2. REFER TO TABLE IIB-703.3.1
- RADIUS CORNER TYPICAL, 1/8" MIN. AND 1/4" MAX. RE: 2/A4.1
- 6" HIGH INTERNATIONAL SYMBOL OF ACCESSIBILITY (ISA) SYMBOL TO BE WHITE, BACKGROUND TO BE COLOR #15090 IN FEDERAL STANDARD 595C. ITS PROPORTIONS SHALL BE PER CBC FIGURE 11B-703.7.2.1. COMPLY WITH CBC 11B-216.8 & 11B-703.2.1
- INTERNATIONAL SYMBOL OF ACCESS FOR HEARING LOSS SYMBOL, COMPLY WITH CBC 11B-703.7.2.4
- BACKGROUND TO BE COLOR RED
- BACKGROUND TO BE SELECTED BY ARCHITECT, WHERE LETTERING OR SYMBOLS OCCUR, TO BE WHITE
- EDGES SHALL BE EASED OR ROUNDED AT 1/16" MIN. OR CHAMFERED AT 1/8" MIN.
- CONTRASTING COLOR 1/4" THICK TRIANGLE ON 1/2" THICK CIRCLE WHICH IS CONTRASTING COLOR OF DOOR. EDGES AND VERTICES ON GEOMETRIC SYMBOLS SHALL BE EASY OR ROUNDED AT 1/8" MINIMUM OR 1/4" MAX. VERTICES SHALL BE RADIUSSED BETWEEN 1/8" AND 1/4" LETTERING TO BE VISUAL (PER 11B-703.5) NOT RAISED

GENERAL SIGNAGE REQUIREMENTS

CODE REQUIREMENTS:
 A. FLOOR LEVEL EXIT SIGNS: PER CBC 1011.6 AND 1011.7
 B. GENERAL REQUIREMENTS: PER CBC 11B-216.1 AND 11B-703.1
 C. SYMBOLS OF ACCESSIBILITY: PER CBC 11B-703.7.2
 D. TACTILE EXIT SIGNS: PER CBC 1011.4

SIGN CONSTRUCTION AND SIZE:
 A. SIGN CONSTRUCTION: PLASTIC WITH MILLED TEXT, SYMBOLS AND BRAILLE. CHEMICALLY WELDED R ADHESIVE APPLIED TEXT, SYMBOLS AND/OR BRAILLE IS NOT ACCEPTABLE.
 B. FINISH AND CONTRAST: TEXT, SYMBOLS AND THEIR BACKGROUND SHALL HAVE A NON-GLARE FINISH. TEXT AND SYMBOLS SHALL HAVE CONTRAST WITH THEIR BACKGROUND PER 11B-703.5.1 FOR VISUAL CHARACTERS; 11B-703.6.2 FOR PICTOGRAMS; 11B-703.7.1 FOR SYMBOLS OF ACCESSIBILITY.
 C. SIZES OF SIGNS SHALL BE AS DETAILED PER DRAWING A6.0

PICTORIAL SYMBOLS FOR RESTROOMS AND VISUAL CHARACTERS
 A. TYPE: RAISED 1/32" INCH MINIMUM
 B. HEIGHT: 6 INCHES MINIMUM
 C. TEXT DESCRIPTORS: TEXT SHALL BE LOCATED DIRECTLY BELOW THE PICTOGRAM FILED AND SHALL COMPLY WITH TACTILE TEXT CHARACTERS AND BRAILLE REQUIREMENTS THIS PAGE
 D. VISUAL CHARACTERS SHALL COMPLY WITH CBC SECTION IIB-703.5 AND SHALL BE 40° MIN. ABOVE FINISH FLOOR OR GROUND
 E. PICTOGRAMS SHALL COMPLY WITH CBC SECTION IIB-703.6
 F. SYMBOLS OF ACCESSIBILITY SHALL COMPLY WITH CBC SECTION IIB-703.7
 G. VARIABLE MESSAGE SIGNS SHALL COMPLY WITH CBC SECTION IIB-703.8

TACTILE TEXT CHARACTER REQUIREMENTS:

- TYPE: UPPER CASE, SANS SERIF PER 11B-703.2.3, NO ITALIC, OBLIQUE, SCRIPT, HIGHLY DECORATIVE OR UNUSUAL FORMS PER 11B-703.2.2 AND 11B-703.2.3
- RAISED CHARACTERS: 1/32" INCH MINIMUM PER 11B-703.2.6
- CHARACTER PROPORTIONS: WIDTH OF THE UPPERCASE "O" IS 60 PERCENT MINIMUM AND 110 PERCENT MAXIMUM OF HEIGHT OF THE UPPERCASE LETTER "I" PER 11B-703.2.4
- STROKE THICKNESS: UPPERCASE LETTER "I" SHALL BE 15 PERCENT MAXIMUM OF THE HEIGHT OF THE CHARACTER PER 11B-703.2.6
- HEIGHT: 5/8 INCH MINIMUM TO 2 INCH MAXIMUM PER 11B-703.2.5
- CHARACTER SPACING: PER 11B-703.2.7 AND IIB-703.2.8, 1/8 INCH MINIMUM AND 4 TIMES THE RAISED CHARACTER STROKE WIDTH MAXIMUM. CHARACTERS SHALL BE SEPARATED FROM RAISED BORDERS AND DECORATIVE ELEMENTS 3/8 INCH MINIMUM
- FORMAT: TEXT SHALL BE IN A HORIZONTAL FORMAT. CBC SECTION IIB-703.2.9
- REFER TO SPECIFICATION 101400, PARAGRAPH 1.04, DESIGN REQUIREMENTS

CALIFORNIA BRAILLE REQUIREMENTS:

CONTRACTED CALIFORNIA GRADE 2 BRAILLE AND SHALL COMPLY WITH CBC SECTION IIB-703.3 AND IIB-703.4. RAISED 1/40 INCH MINIMUM AND 0.037 INCH MAXIMUM ABOVE THE BACKGROUND. ROUNDED DOTS SHALL BE 1/10-INCH ON CENTERS IN EACH CELL WITH 2/10-INCH SPACE BETWEEN CELLS, MEASURED FROM THE SECOND COLUMN OF DOTS IN THE FIRST CELL TO THE FIRST COLUMN OF DOTS IN THE SECOND CELL WITH ROUNDED OR DOME TOPS. REFER TO 2022 CBC TABLE 11B-703.3.1 AND FIGURE 11B-703.3.1

MEASUREMENT RANGE	MINIMUM IN INCHES	TO	MAXIMUM IN INCHES
DOT BASE DIAMETER	0.059 (1.5MM)		0.063 (1.6 MM)
DISTANCE BETWEEN TWO DOTS IN THE SAME CELL	0.100 (2.5MM)		
DISTANCE BETWEEN CORRESPONDING DOTS IN ADJACENT CELLS DOT HEIGHT	0.300 (7.6MM)		0.025 (0.6MM)
DISTANCE BETWEEN CORRESPONDING DOTS FROM ONE CELL DIRECTLY BELOW 1. MEASURED CENTER TO CENTER	0.395 (10MM)		0.400 (10.2MM)