

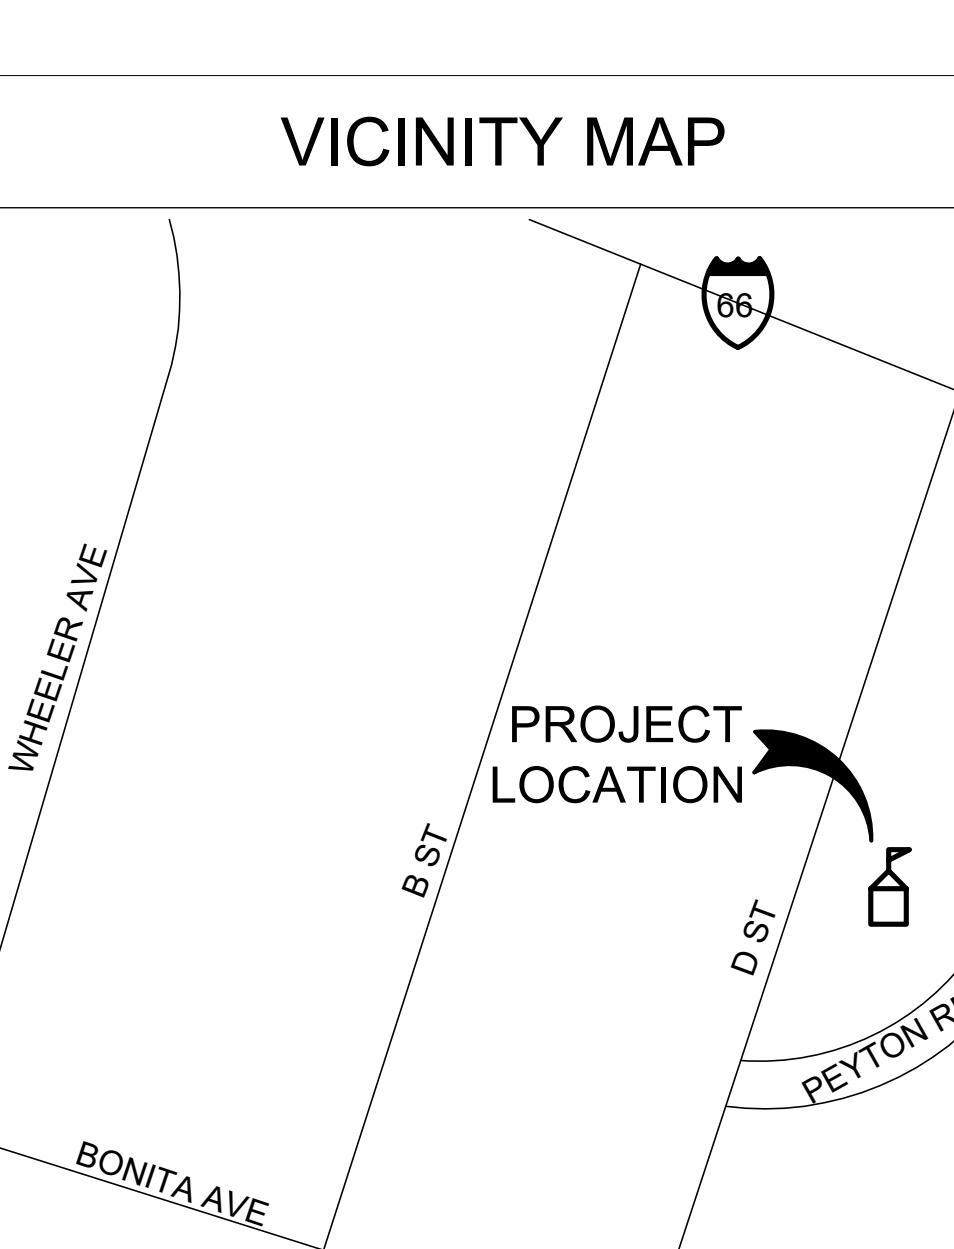


EXHIBIT A - DRAWINGS

BONITA HIGH SCHOOL RUNNING TRACK REPLACEMENT BONITA UNIFIED SCHOOL DISTRICT

SAN DIMAS, CALIFORNIA


ABBREVIATIONS		GENERAL NOTES		APPLICABLE CODES		PROJECT DIRECTORY		INDEX OF DRAWINGS	
@	ANGLE AT	MAR. MARBLE	MAT'L. MATERIAL	1. VERIFY ALL DIMENSIONS, LOCATIONS OF EXISTING UTILITIES, AND CONDITIONS ON JOB SITE PRIOR TO START OF WORK OR PORTIONS OF WORK. NOTIFY ARCHITECT IMMEDIATELY OF ANY DISCREPANCIES BETWEEN ACTUAL FIELD CONDITIONS AND CONSTRUCTION DOCUMENTS. EXISTING CONDITIONS ARE INDICATED AS RESULT OF FIELD OBSERVATIONS, INFORMATION SHOWN ON AVAILABLE DOCUMENTS AND FIELD CONDITIONS AT TIME OF PREPARATION.	PARTIAL LIST OF APPLICABLE CODES AS OF January 1, 2022*	DISTRICT	GENERAL	ARCHITECTS STAMP:	Architecture 9 PLLP
~	CENTERLINE	MAX. MAXIMUM	MC. MEDICINE CABINET	2. NOT ALL MECHANICAL, PLUMBING, AND ELECTRICAL ITEMS MAY BE SHOWN ON THE ARCHITECTURAL DRAWINGS	2022 California Administrative Code (CAC), Part 1, Title 24 CCR*	BONITA UNIFIED SCHOOL DISTRICT 115 W. ALLEN AVENUE SAN DIMAS, CA 91773	G1.0 TITLE SHEET		8816 Foothill Boulevard, Suite 103-224 Rancho Cucamonga, CA 91730 a9contact@architecture9.com
A.B.	ANCHOR BOLT	M.B.B. METAL CORNER BEAD	MECH. MECHANICAL	3. ALL MATERIALS AND WORKMANSHIP SHALL COMPLY WITH ALL GOVERNING CODES, ORDINANCES, REGULATIONS AND LAWS.	2022 California Building Code (CBC), Part 2, Title 24 CCR	SCHOOL	ARCHITECTURAL		
A.F.F.	ABOVE FINISH FLOOR	MET. METAL	MFR. MANUFACTURER	4. WHERE ANY CONFLICT OCCURS BETWEEN REQUIREMENTS OF LAWS, CODES, ORDINANCES, RULES AND REGULATIONS, THE MOST STRINGENT SHALL GOVERN.	2022 California Electrical Code (CEC), Part 3, Title 24 CCR	BONITA HIGH SCHOOL 3102 D. STREET LAVERNE, CA 91750			
A.G.	ASPHALTIC CONCRETE	MIN. MINIMUM	MISC. MISCELLANEOUS	5. IN NO CASE SHALL WORKING DIMENSIONS BE SCALED FROM PLANS, SECTIONS OR DETAILS ON THE DRAWINGS.	2022 California Mechanical Code (CMC), Part 4, Title 24 CCR	ARCHITECT			
ADJ.	ADJACENT	MO. MASONRY OPENING	MTD. MOUNTED	6. DETAILS MARKED WITH 'TYPICAL' SHALL APPLY IN ALL CASES UNLESS SPECIFICALLY NOTED OTHERWISE.	2022 California Plumbing Code (CPC), Part 5, Title 24 CCR	ARCHITECTURE 9, PLLP 8816 FOOTHILL BOULEVARD, SUITE 103-224 RANCHO CUCAMONGA, CA 91730 contact@architecture9.com			
ALUM.	ALUMINUM	MUL. MULLION		7. ENACT ALL MEASURES TO PROTECT AND SAFEGUARD ALL EXISTING ELEMENTS TO REMAIN FROM BEING DAMAGED. REPLACE OR REPAIR EXISTING ELEMENTS DAMAGED BY THE EXECUTION OF THIS CONTRACT TO EQUAL OR BETTER CONDITION.	PARTIAL LIST OF APPLICABLE STANDARDS				
APPROX.	APPROXIMATELY			8. CONTRACTOR SHALL COORDINATE BETWEEN THE REQUIREMENTS OF ALL DISCIPLINES HEREIN AND BETWEEN DRAWING AND SPECIFICATION REQUIREMENTS IN ORDER THAT ALL ITEMS RELATE TO ONE ANOTHER. NOTIFY ARCHITECT IMMEDIATELY REGARDING ANY ITEMS NOT COORDINATED.	For a list of applicable standards, California amendments to the NFPA Standards, refer to CBC Chapter 35 and CFC Chapter 80.				
ARCH.	ARCHITECT			9. THE INTENT OF THESE DRAWINGS AND SPECIFICATIONS IS THAT THE WORK OF CONSTRUCTION, ALTERATION, REHABILITATION OR RECONSTRUCTION SHALL CONFORM TO TITLE 24, CALIFORNIA CODE OF REGULATION (CCR). SHOULD ANY EXISTING CONDITIONS SUCH AS DETERIORATION OR NON-COMPLYING CONSTRUCTION BE DISCOVERED WHICH IS NOT COVERED BY THE CONTRACT DOCUMENTS WHEREIN THE FINISHED WORK WILL NOT COMPLY WITH THE TITLE 24, CALIFORNIA CODE OF REGULATIONS, A CONSTRUCTION CHANGE DOCUMENT (CCD) OR A SEPARATE SET OF PLANS AND SPECIFICATIONS, DETAILING AND SPECIFYING THE REQUIRED WORK SHALL BE SUBMITTED TO AND APPROVED BY THE DIVISION OF THE STATE ARCHITECT BEFORE PROCEEDING WITH THE WORK.					
BD.	BOARD	PART. PARTITION	P.H. PANIC HARDWARE	10. CONTRACTOR SHALL STOP WORK AND NOTIFY ARCHITECT IMMEDIATELY IF ANY ASBESTOS CONTAINING MATERIAL (ACM) OR SUSPECTED ACM IS FOUND DAMAGED OR DISTURBED.					
BET.	BETWEEN	PL. PLATE	P.L. PROPERTY LINE	11. CONTRACTOR SHALL EXERCISE EXTREME CAUTION IN EXCAVATING AND TRENCHING ON THIS SITE TO AVOID EXISTING DUCTS, PIPING, CONDUIT, ETC. AND TO PREVENT HAZARD TO PERSONNEL AND/OR TO EXISTING UNDERGROUND UTILITIES OR STRUCTURES. THE DESIGN PROFESSIONALS ARE NOT RESPONSIBLE FOR THE LOCATION OF UNDERGROUND UTILITIES OR STRUCTURES, WHETHER OR NOT SHOWN AND INSTALLED BY THESE CONTRACT DOCUMENTS. THE CONTRACTOR SHALL IMMEDIATELY NOTIFY THE DISTRICT SHOULD SUCH UNIDENTIFIED CONDITIONS BE DISCOVERED. THESE DRAWINGS AND SPECIFICATIONS DO NOT INCLUDE THE NECESSARY COMPONENTS FOR CONSTRUCTION SAFETY.					
BLDG.	BUILDING	PLAS. M. PLASTIC	PLYWD. PLYWOOD	12. CHANGES TO THE APPROVED DRAWINGS AND SPECIFICATIONS SHALL BE MADE BY ADDENDA OR A CONSTRUCTION CHANGE DOCUMENT (CCD), APPROVED BY DIVISION OF THE STATE ARCHITECT, AS REQUIRED BY SECTION 4-338, PART 1, TITLE 24, CCP.					
BLK.	BLOCK	PR. PAIR	R. RISER	13. WORK SHALL CONFORM WITH THE PREVISIONS OF CHAPTER 33 OF CBC & CFC, 2020 EDITION, "FIRE SAFETY DURING CONSTRUCTION AND DEMOLITION".					
BLKG.	BLOCKING	RAD.A. RADIUS	RB. RUBBER BASE	14. THE ACCEPTANCE TESTING PROCEDURES MUST BE REPEATED, AND DEFICIENCIES MUST BE CORRECTED BY THE BUILDER OR INSTALLING CONTRACTOR UNTIL THE CONSTRUCTION/INSTALLATION OF THE SPECIFIED SYSTEMS CONFORM AND PASS THE REQUIRED ACCEPTANCE CRITERIA.					
BM.	BEAM	RDWD. REDWOOD	RDWD. REDWOOD	15. PROJECT INSPECTORS WILL COLLECT THE FORMS TO CONFIRM THAT THE REQUIRED ACCEPTANCE TEST HAVE BEEN COMPLETED.					
CAB.	CABINET	REF. REFERENCE	REF. REFERENCE	16. A WRITTEN SITE SAFETY PLAN IN COMPLIANCE WITH C.F.C. 3303.1 MUST BE PREPARED AND LABELED ON SITE PRIOR TO COMMENCEMENT OF ANY MOBILIZATION, DEMOLITION AND/OR CONSTRUCTION.					
C.B.	CATCH BASIN	RESIL. RESILIENT	REV. REVISE	17. GRADING PLANS, DRAINAGE IMPROVEMENTS, ROAD AND ACCESS REQUIREMENTS AND ENVIRONMENTAL HEALTH CONSIDERATIONS SHALL COMPLY WITH LOCAL ORDINANCES.					
C.F.	CURB FACE	RM. ROOM	RM. ROOM	18. ALL WORK SHALL CONFORM TO 2022 TITLE 24, CALIFORNIA CODE OF REGULATIONS (CCR)					
C.J.	CONTROL JOINT	ROUGH OPENING	REFR. REFRIGERATOR	19. A DSA ACCEPTED TESTING LABORATORY DIRECTLY EMPLOYED BY DISTRICT (OWNER) SHALL CONDUCT ALL THE REQUIRED TESTS AND INSPECTIONS FOR THE PROJECT.					
CLG.	CEILING	REG. REGISTER	REG. REGISTER						
C.O.	CONCRETE OPENING	REINF. REINFORCEMENT	REQD. REQUIRED						
COL.	COLUMN	REQD. REQUIRED	ROUGH. ROUGH						
CONC.	CONCRETE	ROUGH OPENING	ROUGH OPENING						
C.M.U.	CONCRETE MASONRY UNITS	SLID'G. SLIDING	SM. SMOOTH FACE						
COMPO.	CONTINUOUS	SOLID'G. SOLID	S.M.S. SHEET-METAL SCREW						
CONTR.	CONTRACTOR	SOLID CORE	SPECIFICATIONS						
CORR.	CORRIDOR	SCHED. SCHEDULE	SP. SPLIT FACE						
DET.	DETAIL	SECT. SECTION	SP. F. SPLIT FACE						
D.F.	DRINKING FOUNTAIN	SHRT. SHEET	SQ. SQUARE						
D.G.	DECOMPOSED GRANITE	SIM. SIMILAR	S.S. SERVICE SINK						
DIA.	DIA. DIAMETER	SOLID'G. SOLID	SST. STAINLESS STEEL						
DIM.	DIMENSION	ST. STATIONARY	STAT. STATIONARY						
DIV.	DIVISION	STD. STANDARD	STD. STANDARD						
DN.	DN. DRAIN	STL. STEEL	STRUCT. STRUCTURAL						
DBL.	DOUBLE	STRUCT. STRUCTURAL	SUSP. SUSPENDED						
DWG.	DWGS. DOWNSPOUT DRAWING	SYM. SYMMETRICAL	SYMM. SYMMETRICAL						
(E)	EXISTING	S. SOUTH	SB. SPLASH BLOCK						
EA.	EACH	S.D. STORM DRAIN	S.D. STORM DRAIN						
E.J.	EXPANSION JOINT	S.C. SOLID CORE	S.C. SOLID CORE						
ELEC.	ELECTRIC	SCHED. SCHEDULE	SPEC. SPECIFICATIONS						
ELEV.	ELEVATION	SECT. SECTION	SP. F. SPLIT FACE						
ENT.	ENTRANCE	SHRT. SHEET	SQ. SQUARE						
EMER.	EMERGENCY	SIM. SIMILAR	S.S. SERVICE SINK						
ENCL.	ENCLOSURE	SOLID'G. SOLID	SST. STAINLESS STEEL						
EQ.	EQUAL	ST. STATIONARY	STAT. STATIONARY						
EQUIP.	EQUIPMENT	STD. STANDARD	STD. STANDARD						
E.G.	EXISTING GRADE	STL. STEEL	STRUCT. STRUCTURAL						
EXPO.	EXPOSED	STRUCT. STRUCTURAL	SUSP. SUSPENDED						
EXP.	EXPANSION	SYM. SYMMETRICAL	SYMM. SYMMETRICAL						
EXT.	EXTERIOR								
F.A.	FLOOR DRAIN	T.	TREAD						
F.B.	FIRE EXTINGUISHER	T.B.	TACKBOARD						
F.B.C.A.	FIRE EXTINGUISHER CABINET	T.B.B.	TOP AND BOTTOM						
F.D.	FINISH GRADE	T.C.	TOP OF CURB						
F.E.	FIRE HYDRANT	T.D.	TOWEL DISPENSER						
F.E.W.S.	FLATHEAD WOOD SCREWS	T.G.	TOP OF GRADE						
FIN.	FINISH	T.O.W.	TOP OF MASONRY						
FLASH.	FLASHING	T.O.R.	TOP OF ROOFING						
FLUOR.	FLUORESCENT	T.O.S.	TOP OF SHEATHING						
F.O.A.	FACE OF CONCRETE	T.P.	TOP OF PAVING						
F.O.F.	FACE OF FINISH	TEL.	TOP OF WALL						
F.O.M.	FACE OF MASONRY	TEMP.	TELEPHONE						
F.O.S.	FACE OF STUD	TR.	TEMPERATURE						
F.O.V.A.	FACE OF VENEER	TR.	TRANSOM						
F.R.A.B.	FIRE RATED ASSEMBLY	TYP.	TYPICAL						
F.R.P.C.	FIBERGLASS REINFORCED PANELS	U.N.O.	UNLESS NOTED OTHERWISE						
F.S.	FLOOR SINK	U.O.F.	URINAL						
F.T.	FOOT OR FEET	UR.	URINAL						
FURR.	FURRING	VAR.	VARIES						
GA.	GAUGE	V.C.T.	VINYL COMPOSITION TILE						
GALV.	GALVANIZED	VERT.	VERTICAL						
G.I.	GALVANIZED IRON	WEST.	VESTIBULE						
GL.	GLASS	V.I.F.	VERIFY IN FIELD						
GLU LAM.	GLUE LAMINATED GROUND	W.	WITH						
GR.	GRADE	W.C.	WATER CLOSET						
GR..A.	GYPSUM	W.	WOOD						
H.B.	HOSE HIB	W.I.	WROUGHT IRON						
H.M.	HOLLOW METAL								
HORIZ.	HORIZONTAL								
HR.	HOUR								
HT.	HEIGHT								
HTG.	HEATING								
HDWD.	HWDRD.								
I.D.	INSIDE DIAMETER								
INSUL.	INSULATION								
INT.	INTERIOR								
INV.	INVERT								
JAN.	JANITOR								
LAB.	LABORATORY								
PLAM.	LAMINATED PLASTIC								
LAV.	LAVATORY								
LVR.	LOUVER								



PROJECT DESCRIPTION

REPLACEMENT OF (E) SYNTHETIC RUNNING TRACK, ACCESSIBLE PARKING STRIPING PAINT AND RELATED PATH OF TRAVEL IMPROVEMENTS

G1.0

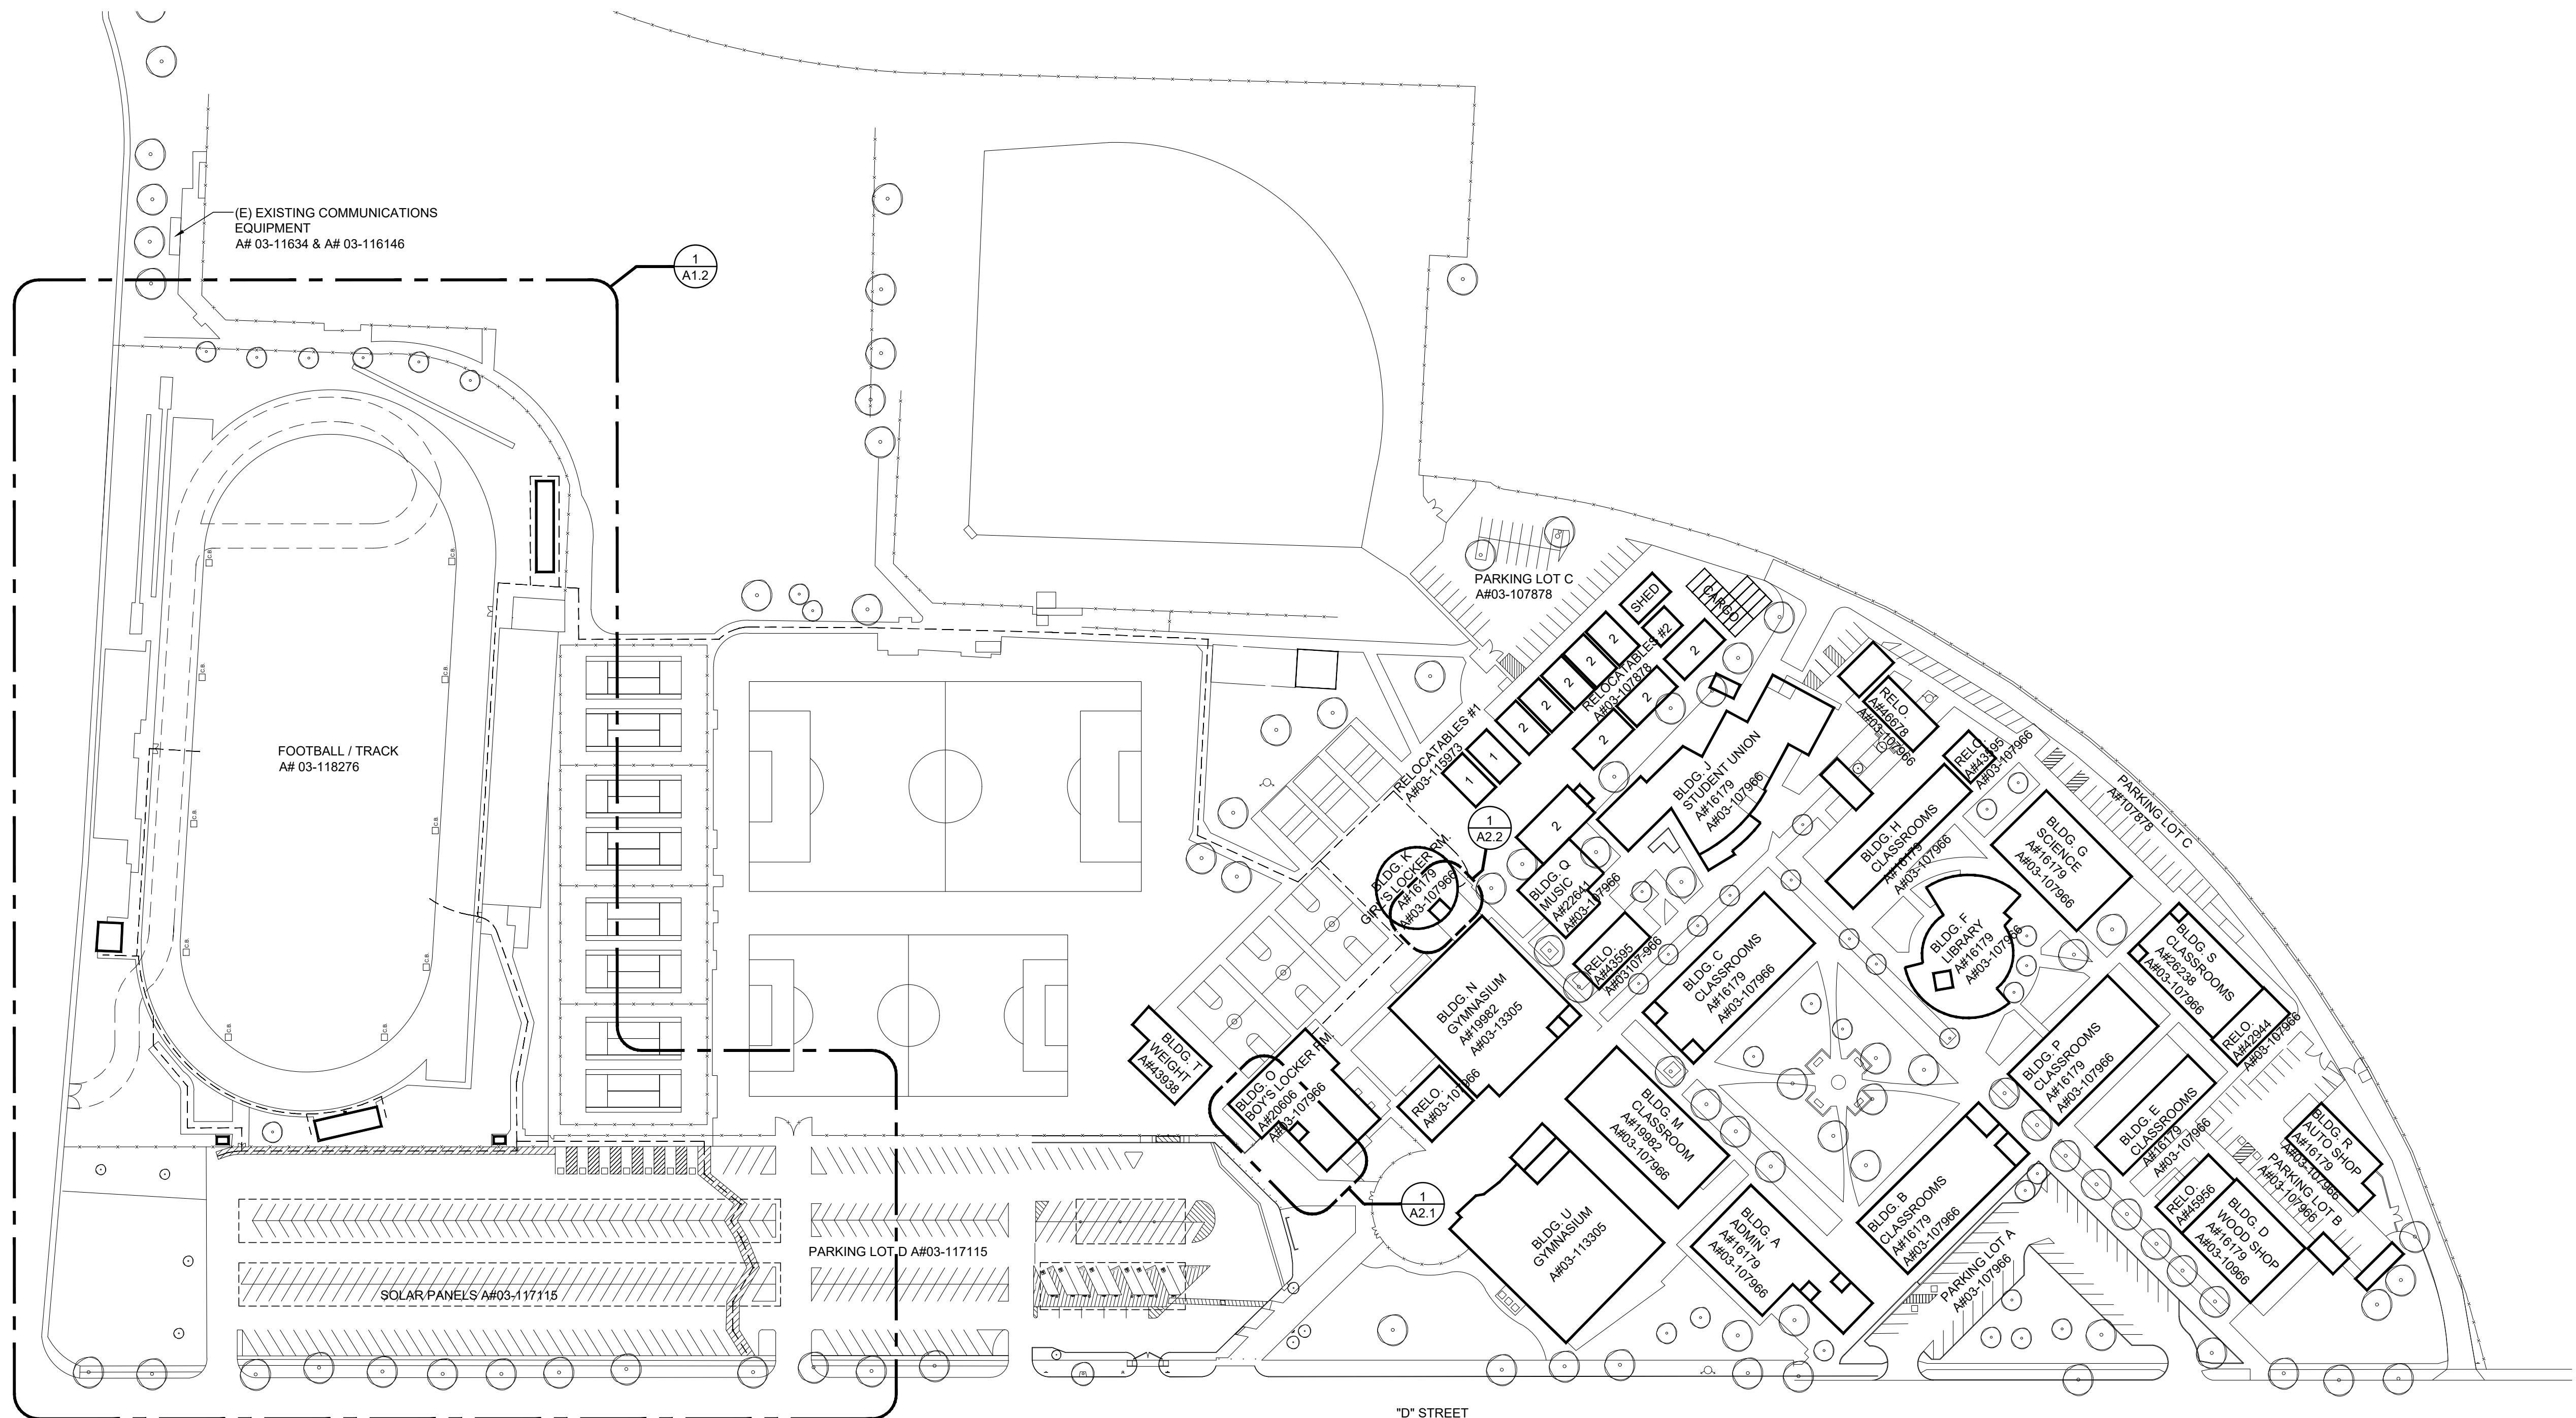

1 OVERALL SITE PLAN 
SCALE: 1" = 80'

LEGEND

— — — EXISTING PATH OF TRAVEL A#03-118276

DESIGN PROFESSIONAL IN GENERAL RESPONSIBLE CHARGE STATEMENT:

"THE P.O.T. IDENTIFIED IN THESE CONSTRUCTION DOCUMENTS IS COMPLIANT WITH THE CURRENT APPLICABLE CALIFORNIA BUILDING CODE ACCESSIBILITY PROVISIONS FOR PATH OF TRAVEL REQUIREMENTS FOR ALTERATIONS, ADDITIONS AND STRUCTURAL REPAIRS. AS PART OF THE DESIGN OF THIS PROJECT, THE P.O.T. WAS EXAMINED AND ANY ELEMENTS, COMPONENTS, OR PORTIONS OF THE P.O.T. THAT WERE DETERMINED TO BE NONCOMPLIANT 1) HAVE BEEN IDENTIFIED AND 2) THE CORRECTIVE WORK NECESSARY TO BRING THEM INTO COMPLIANCE HAS BEEN INCLUDED WITHIN THE SCOPE OF THIS PROJECT'S WORK THROUGH DETAILS, DRAWINGS AND SPECIFICATIONS INCORPORATED INTO THESE CONSTRUCTION DOCUMENTS. ANY NONCOMPLIANT ELEMENTS, FINDING OF UNREASONABLE HARDSHIPS ARE SO INDICATED IN THESE CONSTRUCTION DOCUMENTS."

DURING CONSTRUCTION, IF P.O.T. ITEMS WITHIN THE SCOPE OF THE PROJECT REPRESENTED AS CODE COMPLIANT ARE FOUND TO BE NONCONFORMING BEYOND REASONABLE CONSTRUCTION TOLERANCES, THEY SHALL BE BROUGHT INTO COMPLIANCE WITH THE CBC AS A PART OF THIS PROJECT BY MEANS OF A CONSTRUCTION CHANGE DOCUMENT."

PATH OF TRAVEL TECHNICAL REQUIREMENTS FOR ACCESSIBLE ROUTE

"ACCESSIBLE PATH OF TRAVEL AS INDICATED ON PLAN IS A BARRIER-FREE ACCESS ROUTE WITHOUT ABRUPT LEVEL CHANGES EXCEEDING 1/2" IF BEVELED AT 1:2 MAXIMUM SLOPE OR VERTICAL LEVEL CHANGES 4" MAXIMUM AND AT LEAST 48" IN WIDTH. SURFACE IS STABLE, FIRM, AND SLIP-RESISTANT. CROSS-SLOPE SHALL NOT BE STEEPER THAN 1:48 AND SLOPE IN THE DIRECTION OF THE TRAVEL SHALL NOT BE STEEPER THAN 1:20. ACCESSIBLE PATH OF TRAVEL SHALL BE MAINTAINED FREE OF OVERHANGING OBSTRUCTIONS TO 80" MINIMUM AND FREE OF OBJECTS PROTRUDING MORE THAN 4" FROM THE WALL, ABOVE 27" AND LESS THAN 80" ABOVE THE FLOOR. ARCHITECT HAS VERIFIED THAT THERE ARE NO BARRIERS IN THE PATH OF TRAVEL."

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ARCHITECTS STAMP:



CONSULTANT:


CONSULTANTS STAMP:

SCHOOL DISTRICT:
**BONITA UNIFIED
SCHOOL DISTRICT**

PROJECT:
**BONITA
HIGH SCHOOL
RUNNING TRACK
REPLACEMENT**

BONITA HIGH SCHOOL
3102 D STREET
LAVERNE, CA. 91750


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DATE: 3/12/25

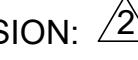REVISION:  DATE: _____
REVISION:  DATE: _____

DRAWING TITLE:
**OVERALL
SITE PLAN**

DRAWING NO.:

A1.1

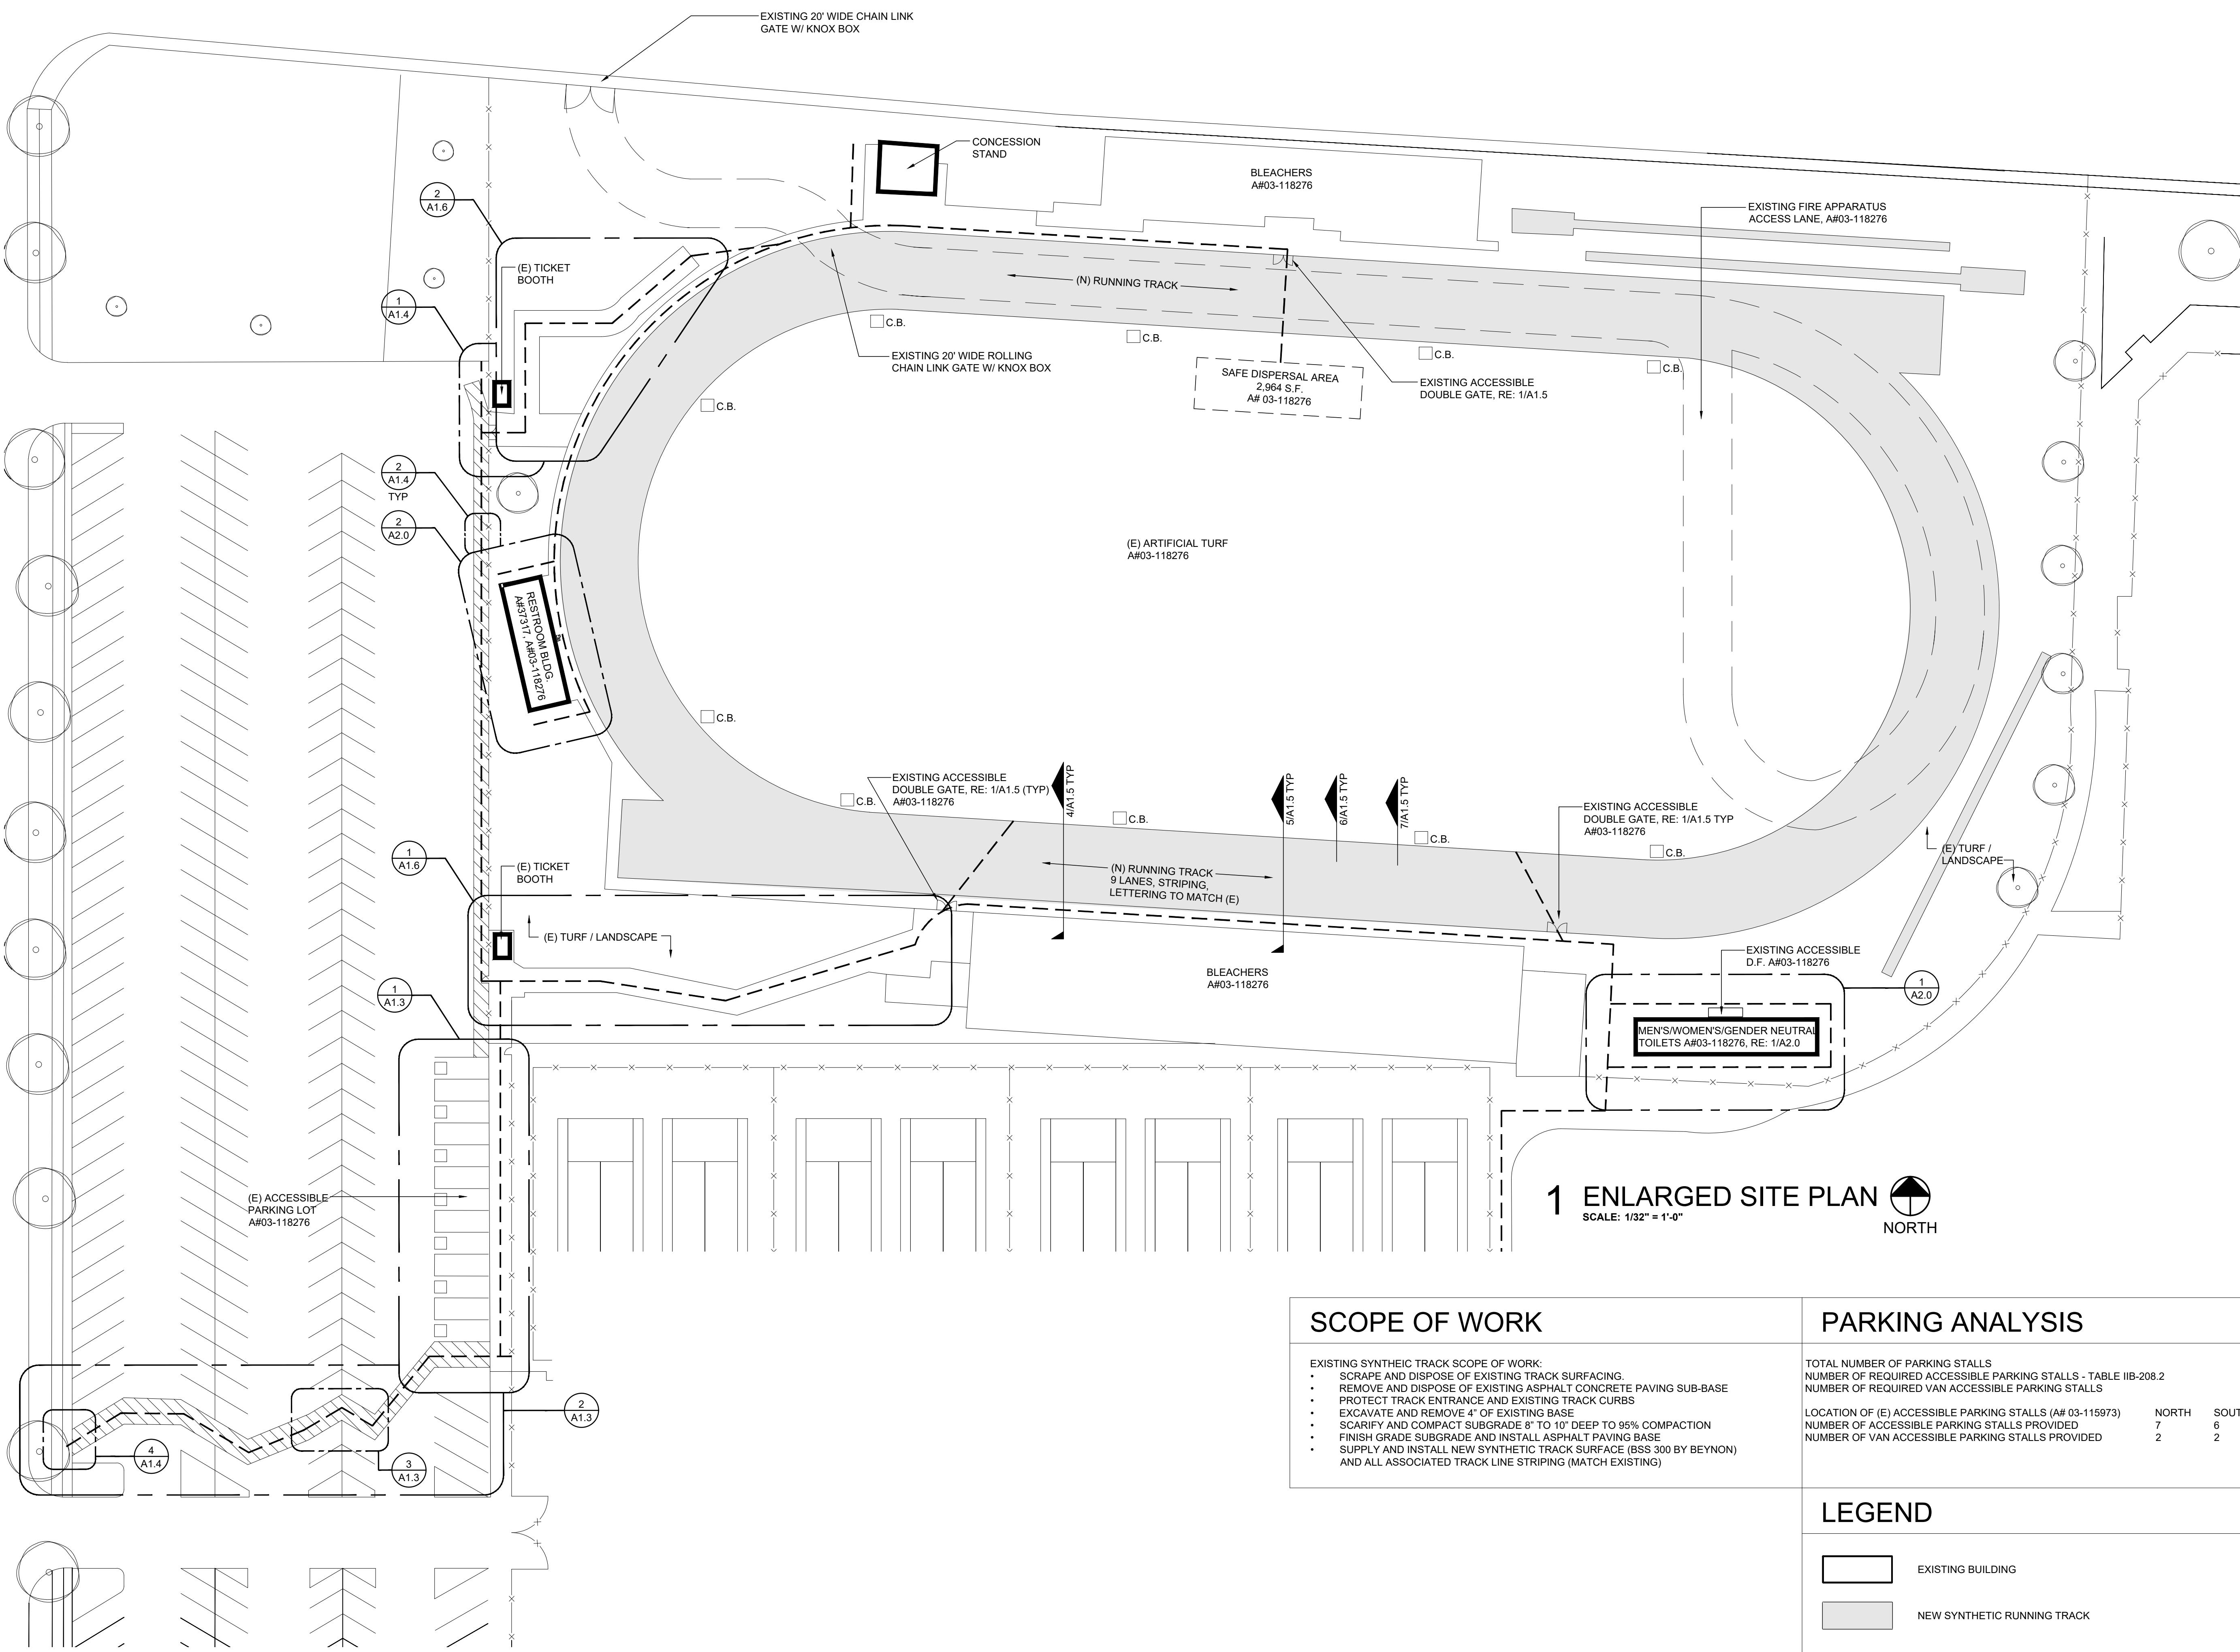

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CONSULTANT:

CONSULTANTS STAMP:

SCHOOL DISTRICT:
BONITA UNIFIED
SCHOOL DISTRICT

PROJECT:
BONITA
HIGH SCHOOL
RUNNING TRACK
REPLACEMENT

BONITA HIGH SCHOOL
3102 D. STREET
LAVERNE, CA. 91750




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DATE: 3/12/25

REVISION: DATE: _____
REVISION: DATE: _____


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ENLARGED
SITE PLAN

DRAWING NO.:

A1.2

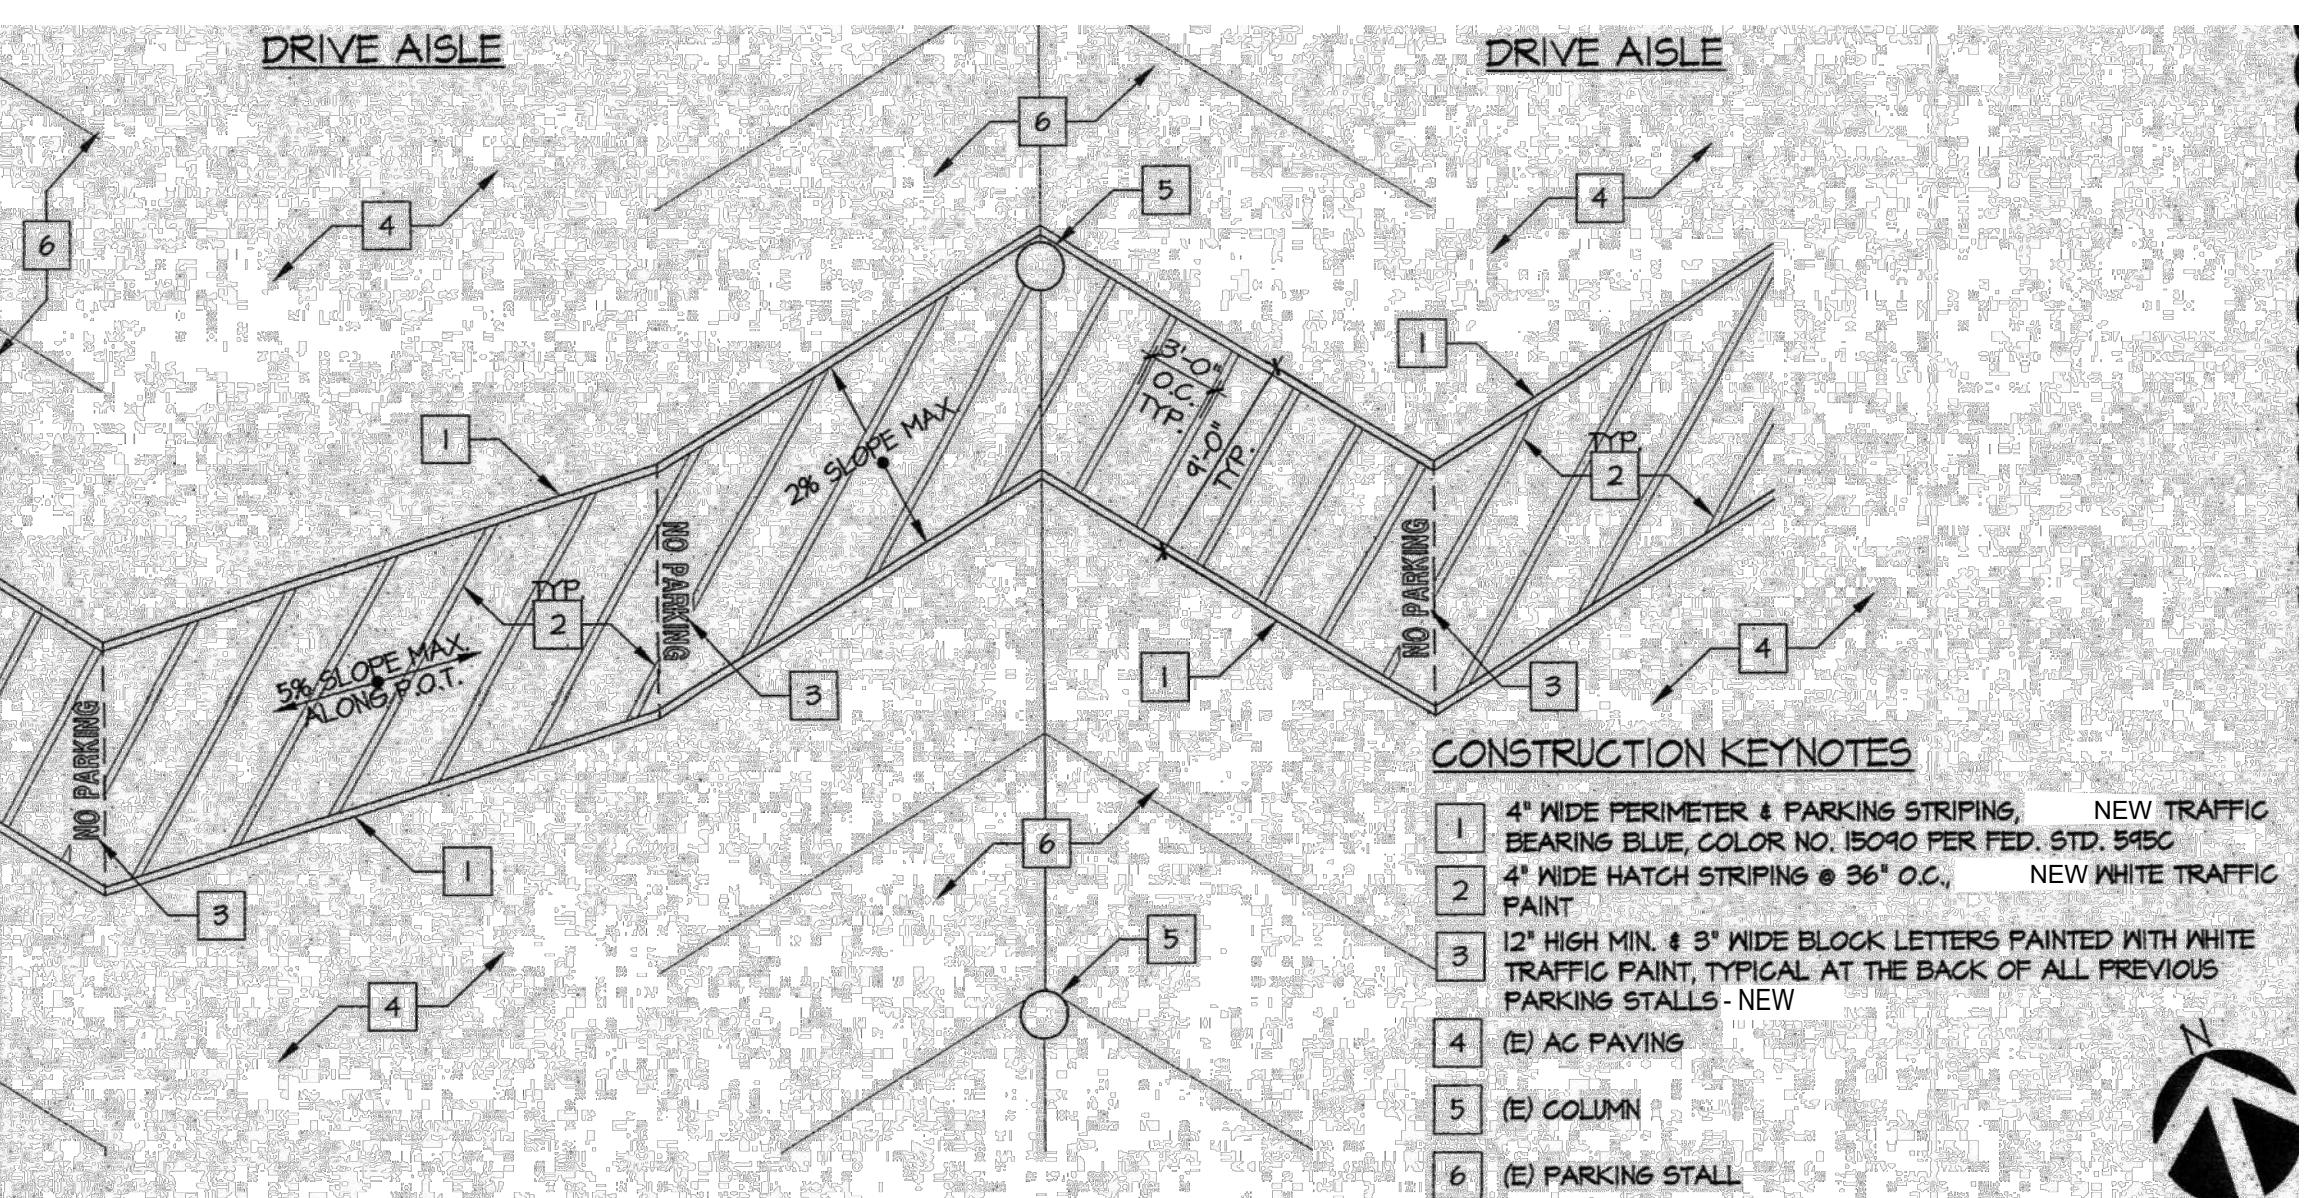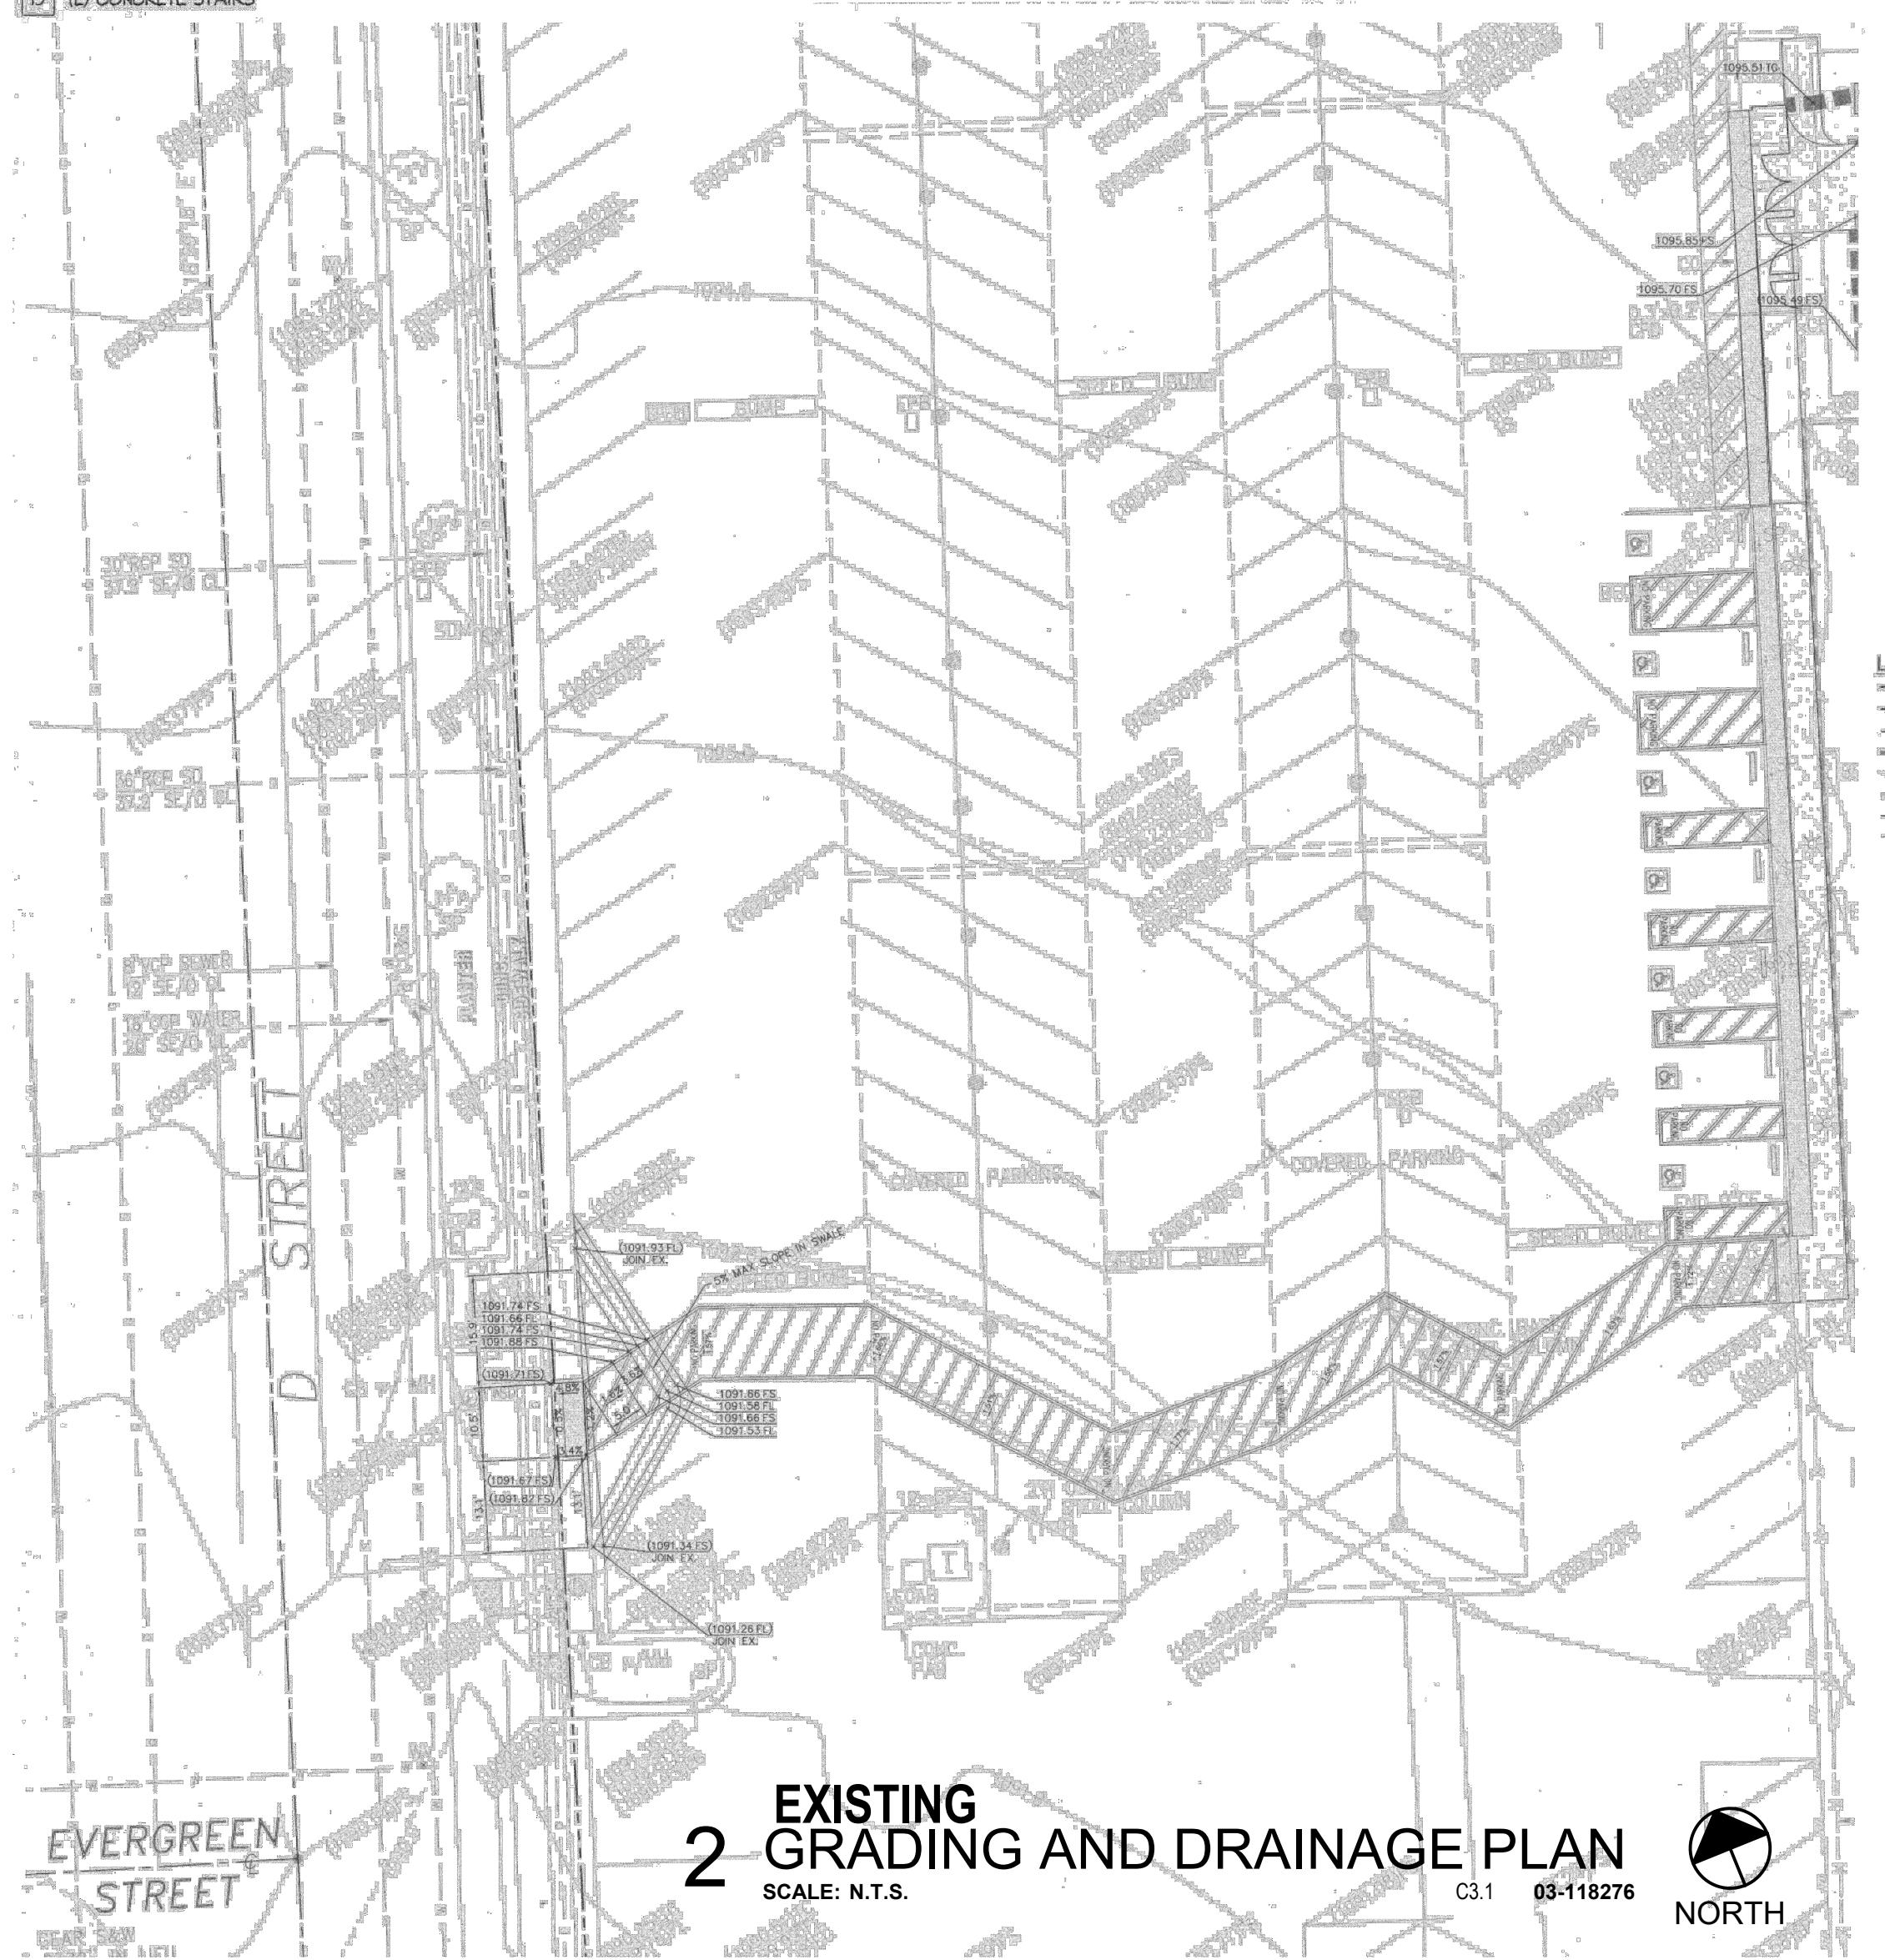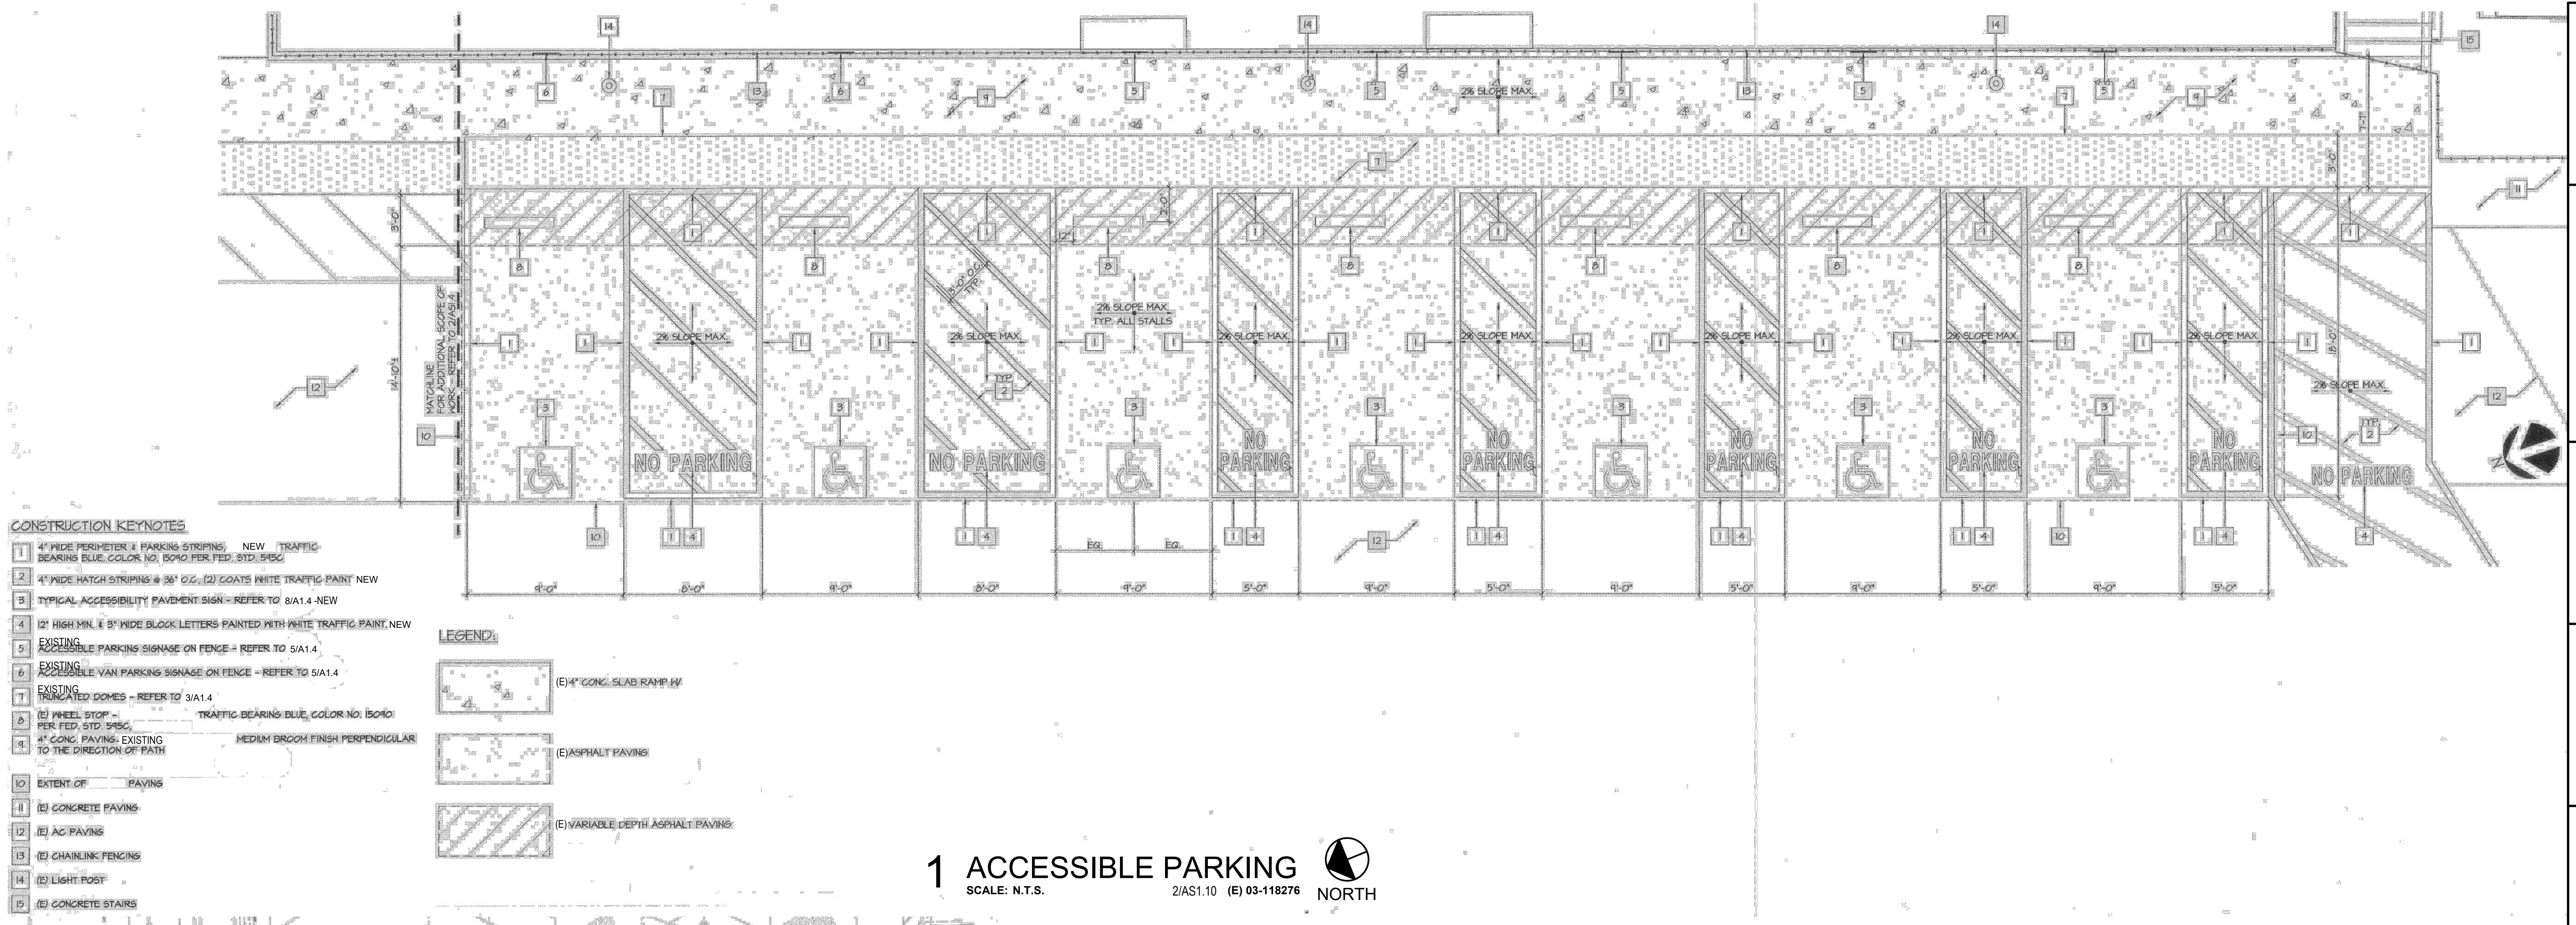

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ARCHITECTS STAMP:

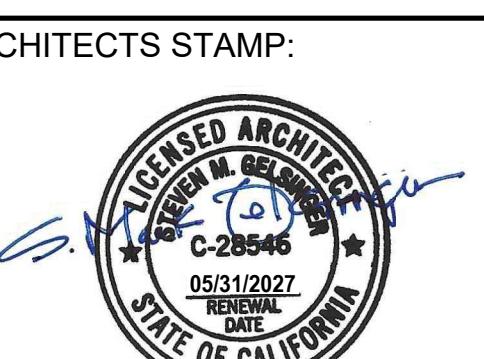CONSULTANT:

SCHOOL DISTRICT:
**BONITA UNIFIED
SCHOOL DISTRICT**

PROJECT:
**BONITA
HIGH SCHOOL
RUNNING TRACK
REPLACEMENT**

BONITA HIGH SCHOOL
3102 D STREET
LAVERNE, CA. 91750


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DATE: 3/12/25

REVISION: DATE: _____
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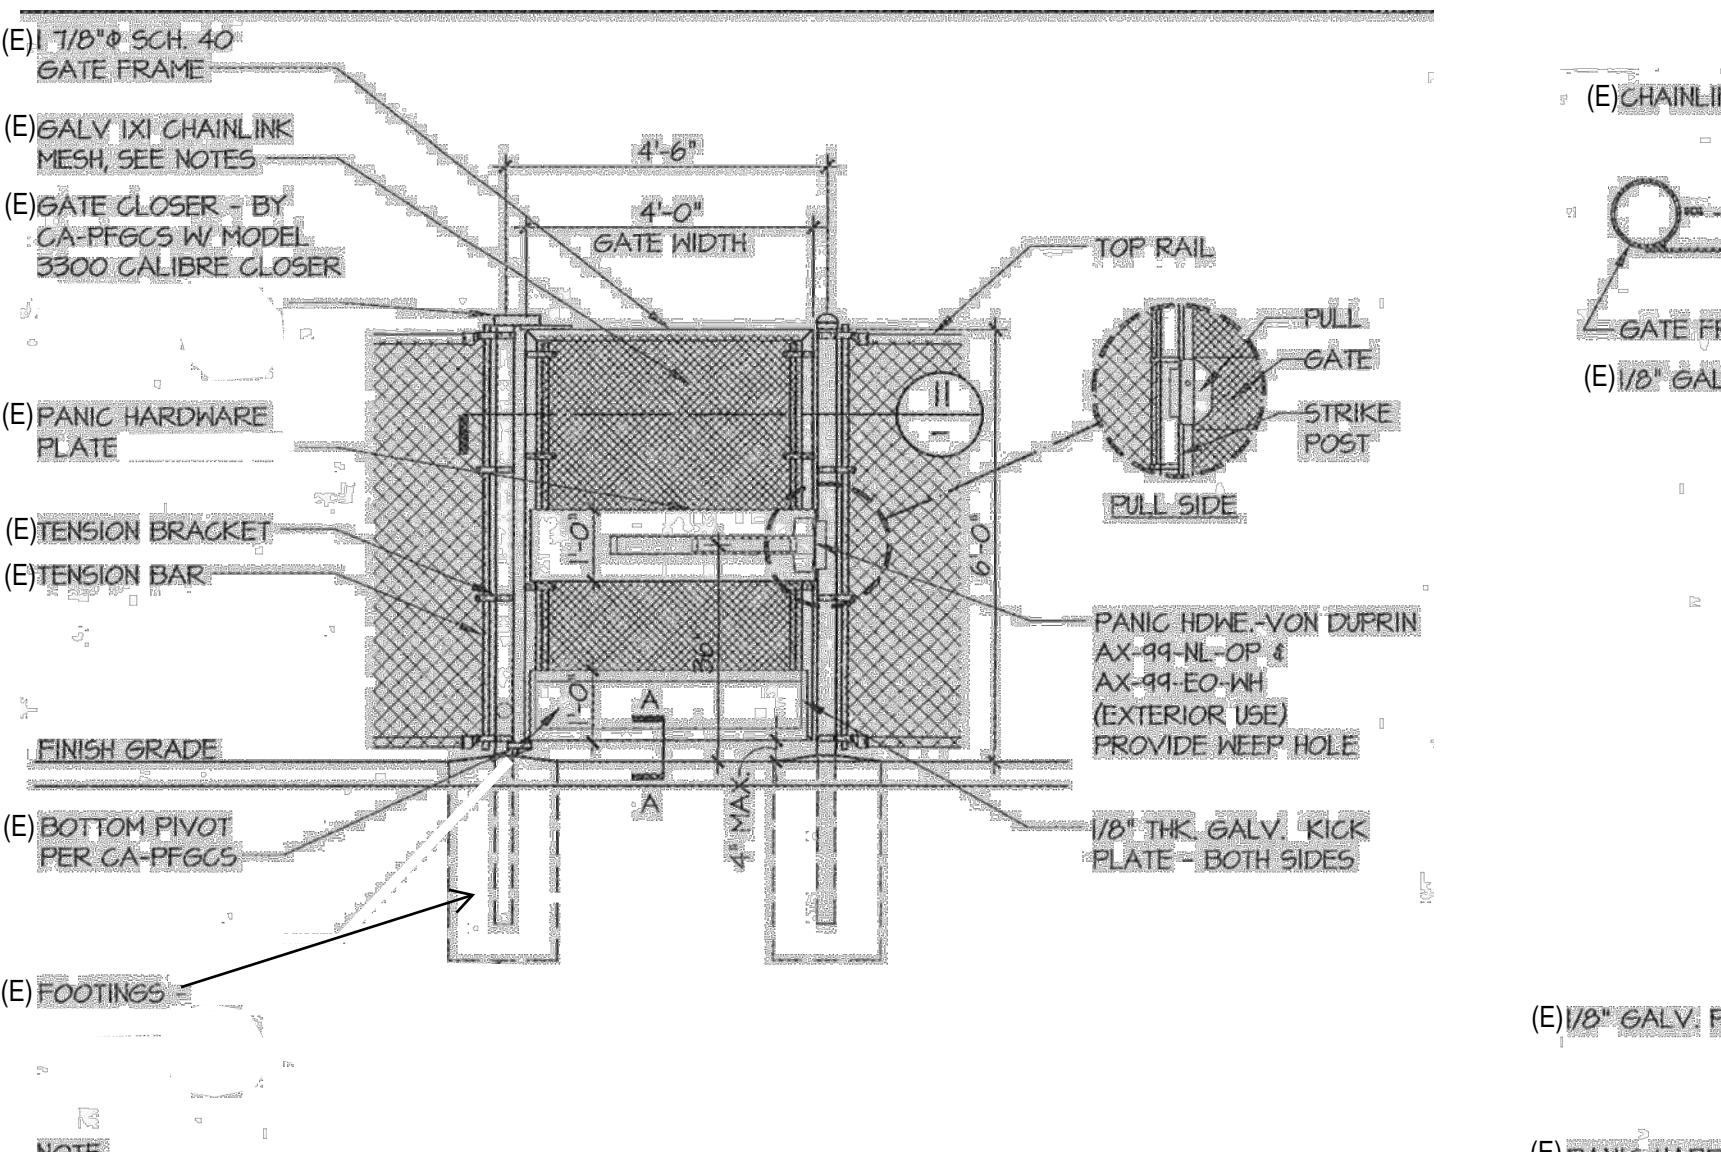
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**ACCESSIBLE
PARKING**

DRAWING NO.:

A1.3

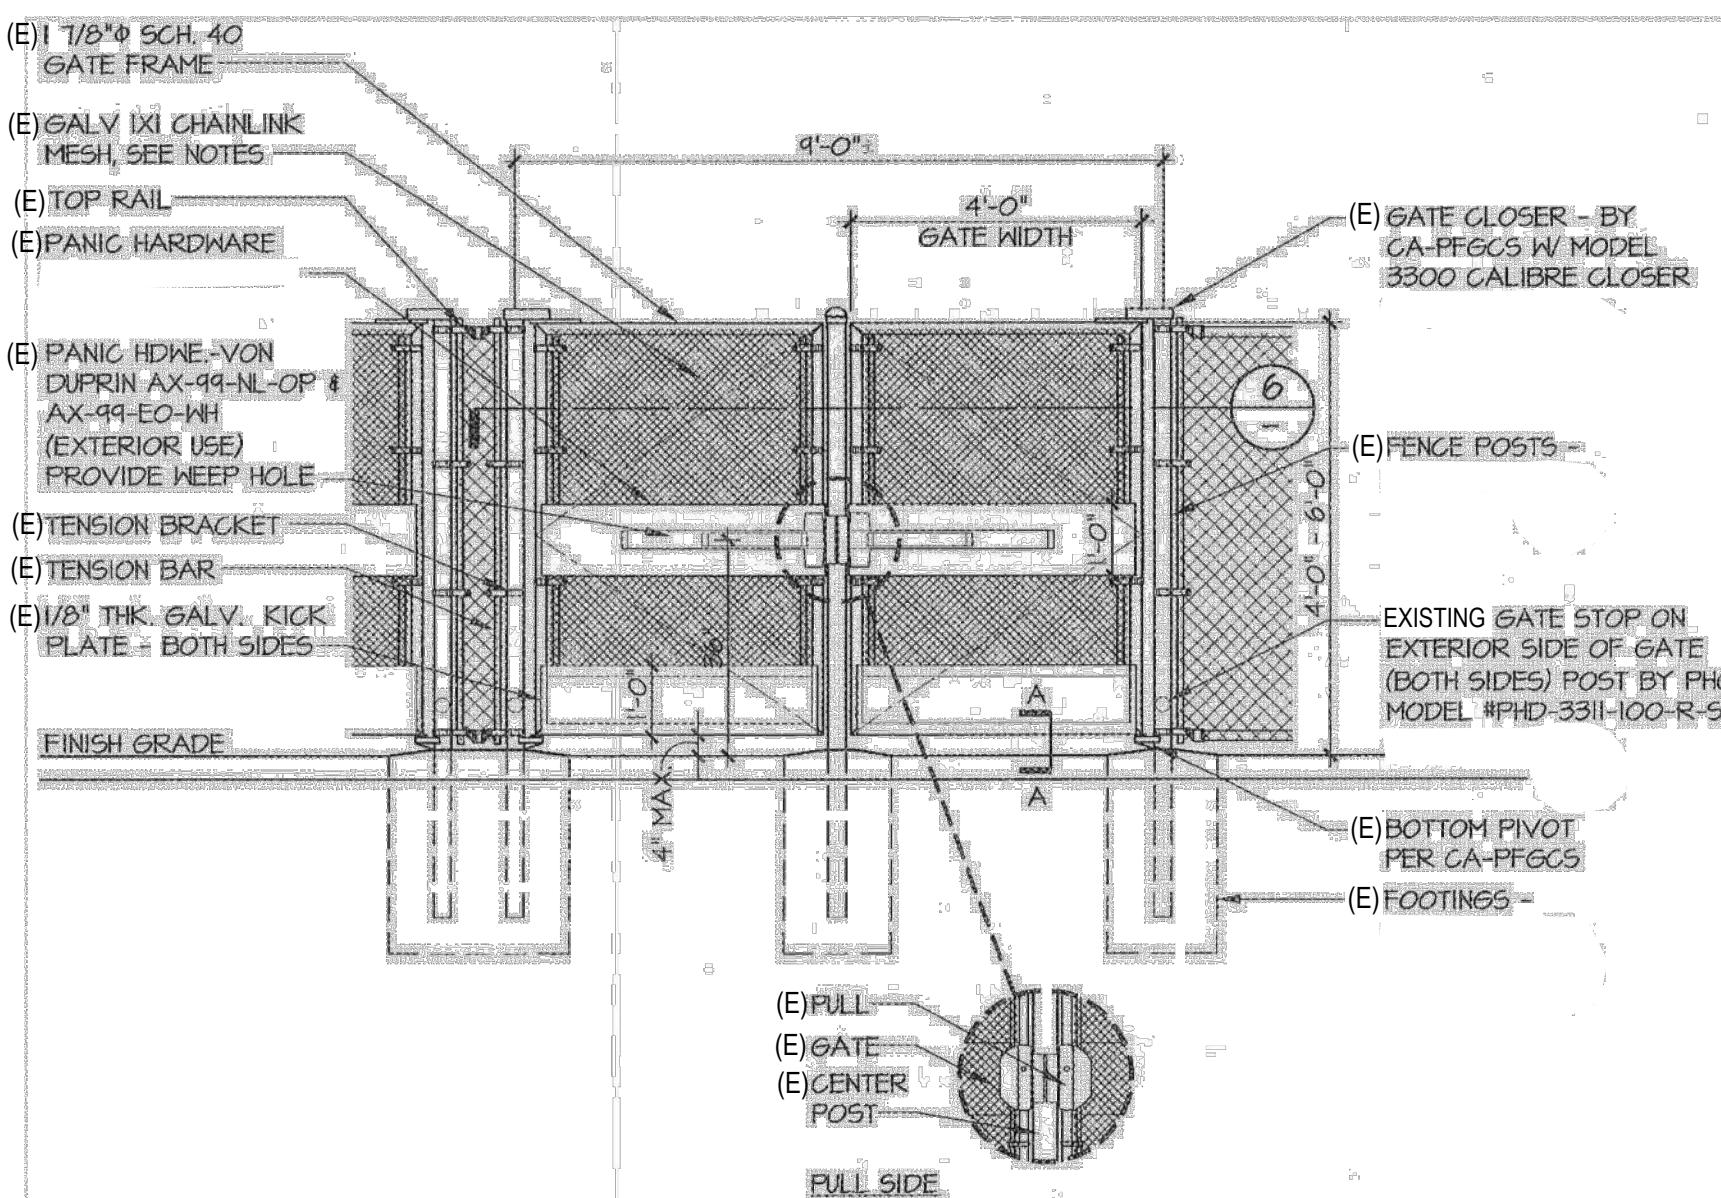


1 EXISTING DOUBLE CHAINLINK FENCE W/ PANIC HARDWARE
SCALE: N.T.S. 1/AS1.7 A# 03-118276




2 EXISTING CHAINLINK FENCE W/ PANIC HARDWARE
SCALE: N.T.S. 2/AS1.5 A# 03-118276




3 EXISTING PANIC HARDWARE PLATE @ CHAINLINK FENCE GATE
SCALE: N.T.S. 3/AS1.5 A# 03-118276

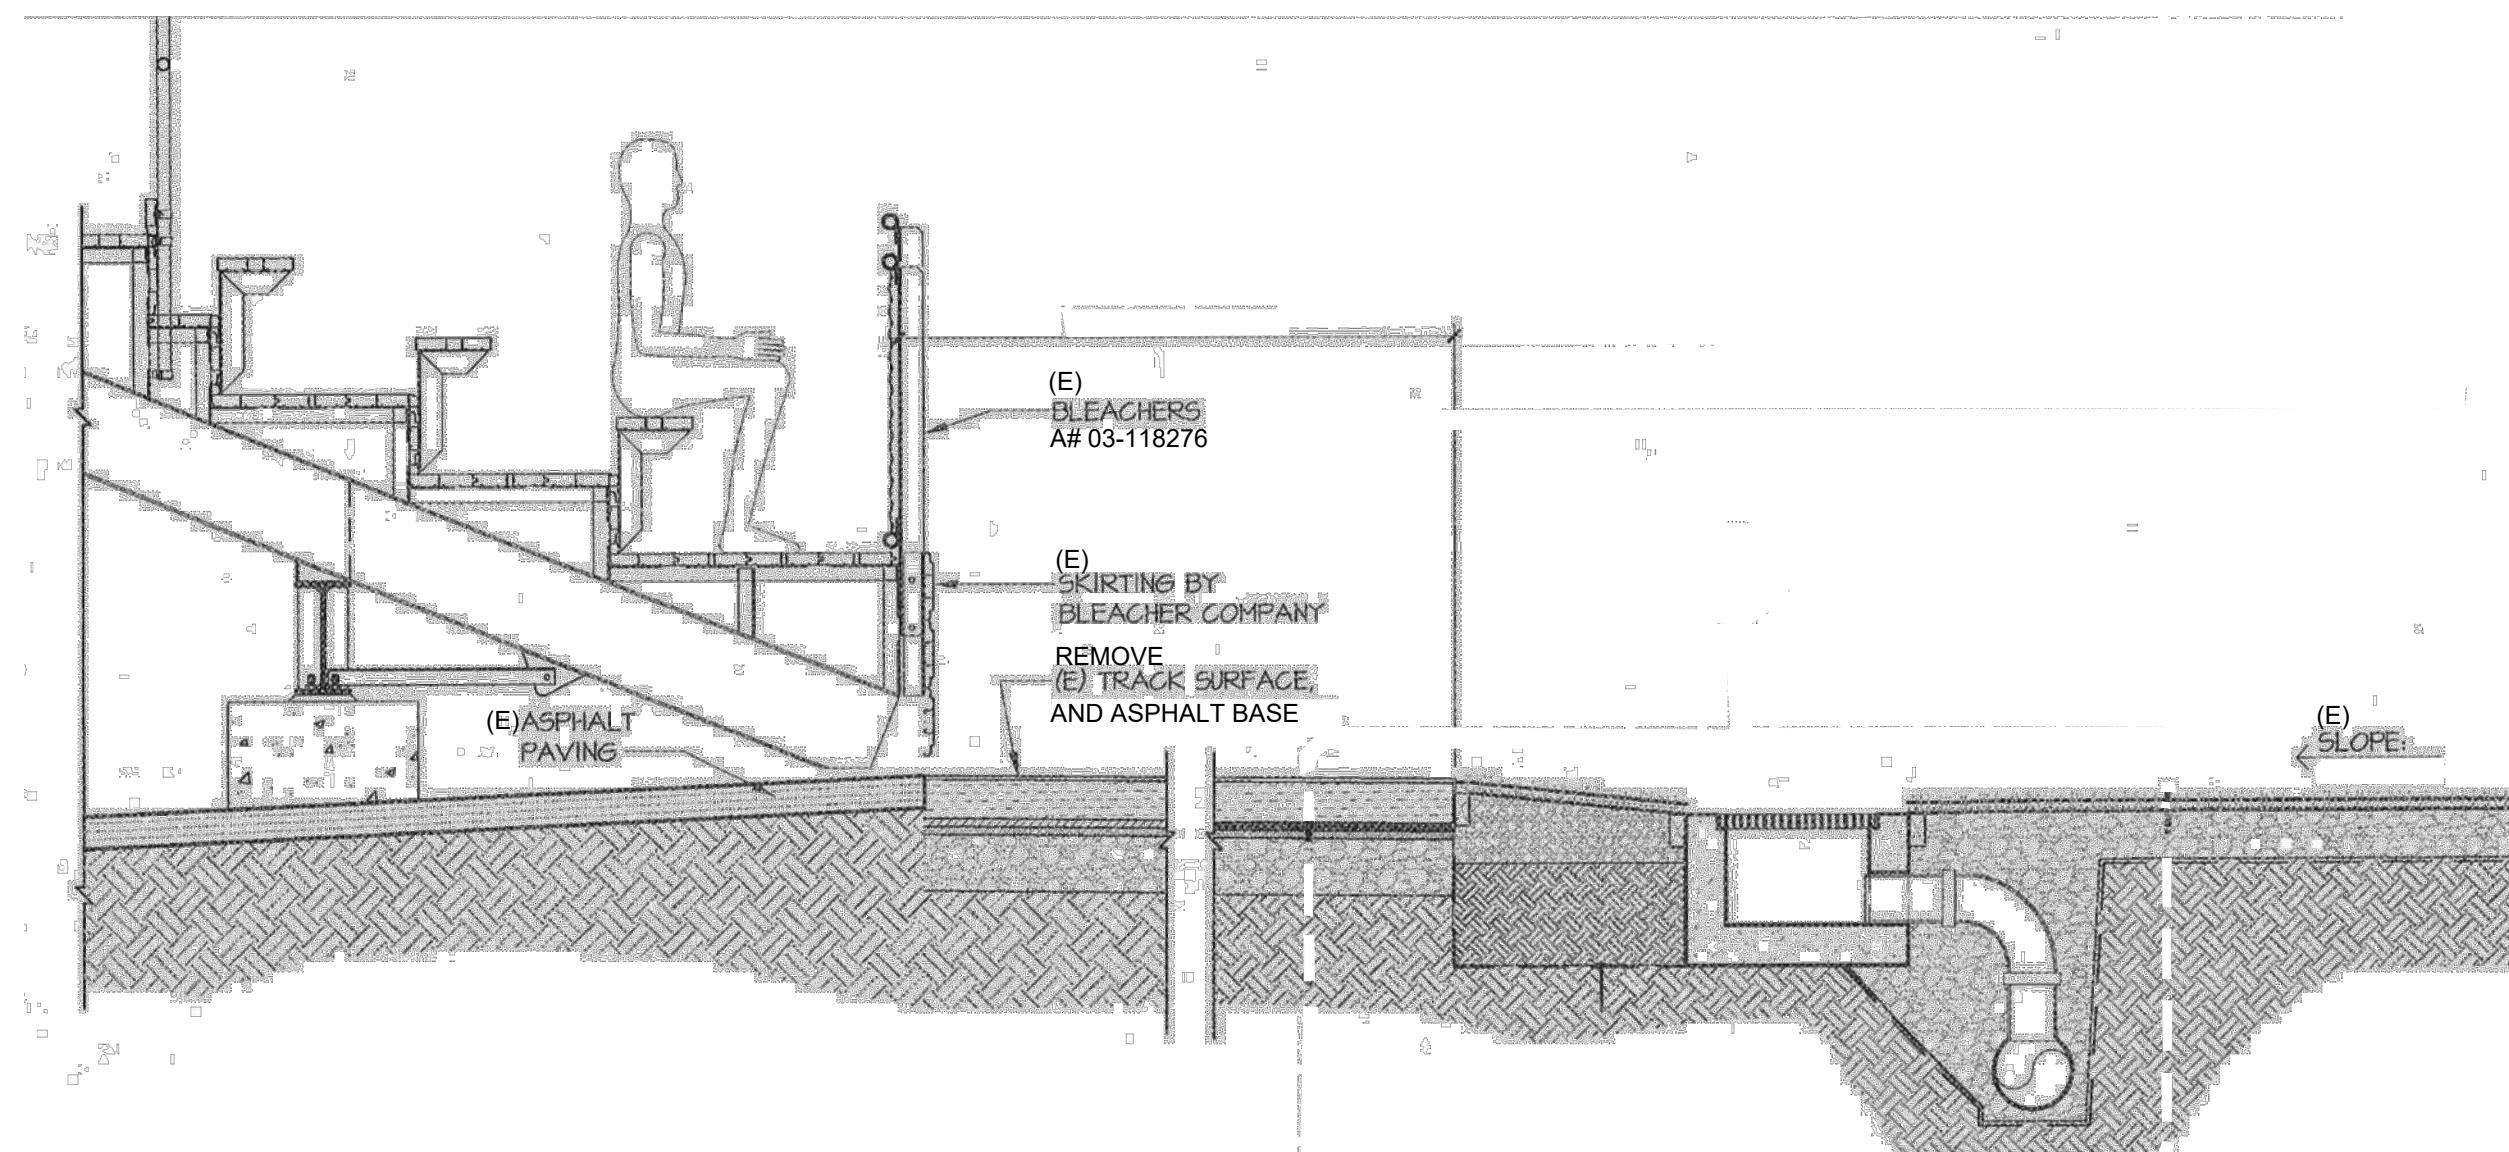


4 SECTION THRU STADIUM FIELD - DEMOLITION
SCALE: N.T.S. 1/AS1.7 A# 03-118276

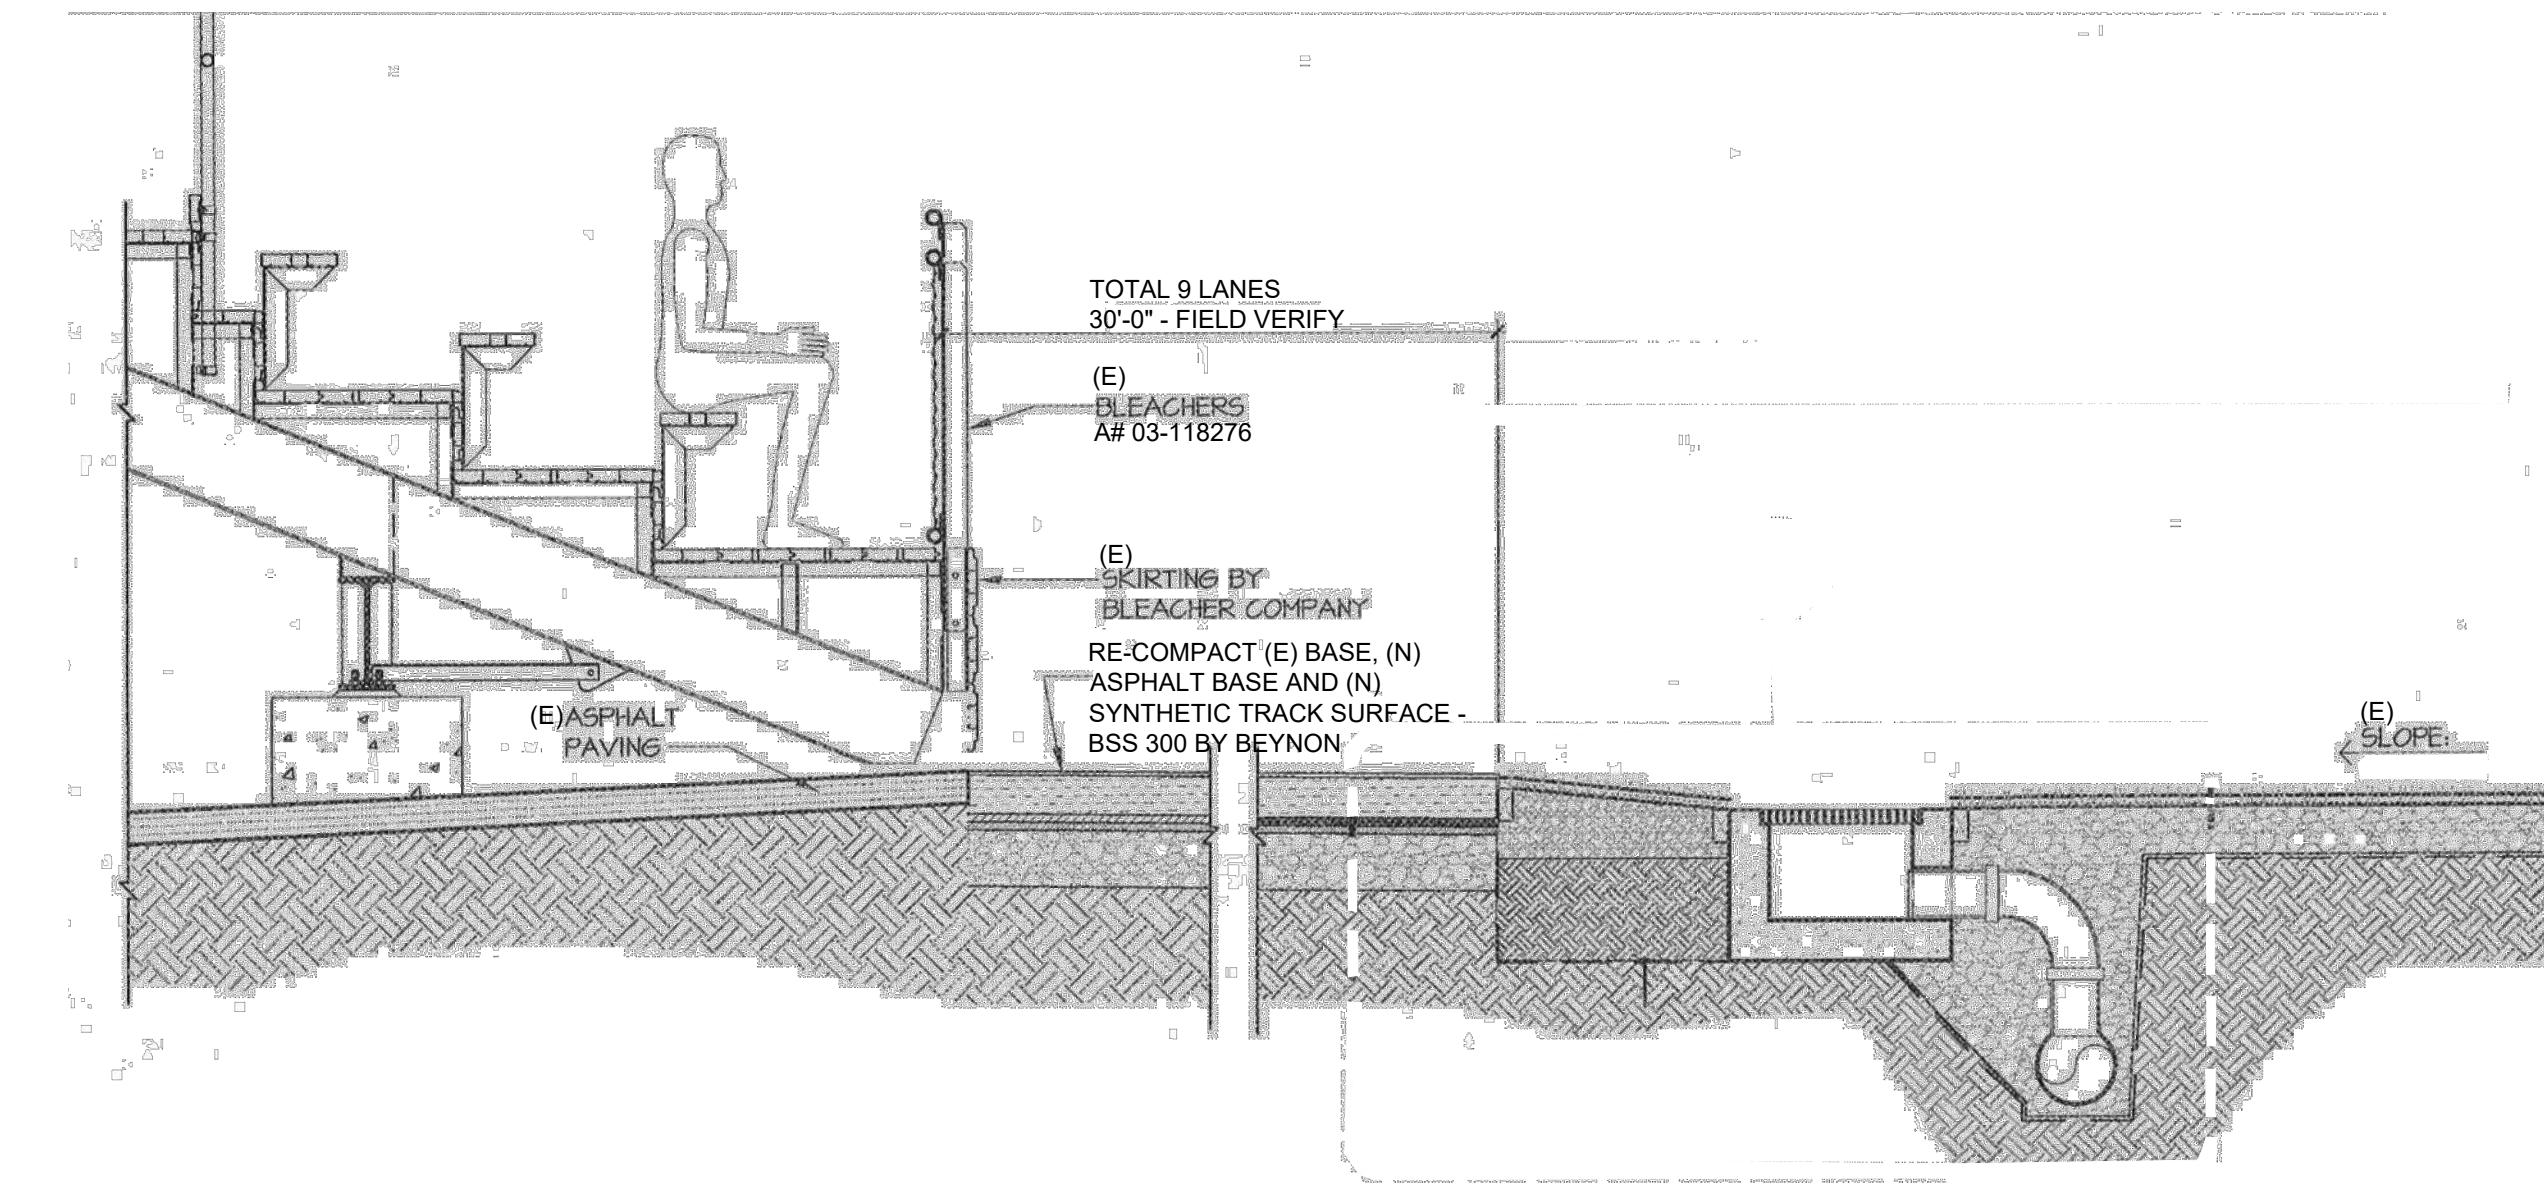

5 SECTION THRU STADIUM FIELD - NEW
SCALE: N.T.S.

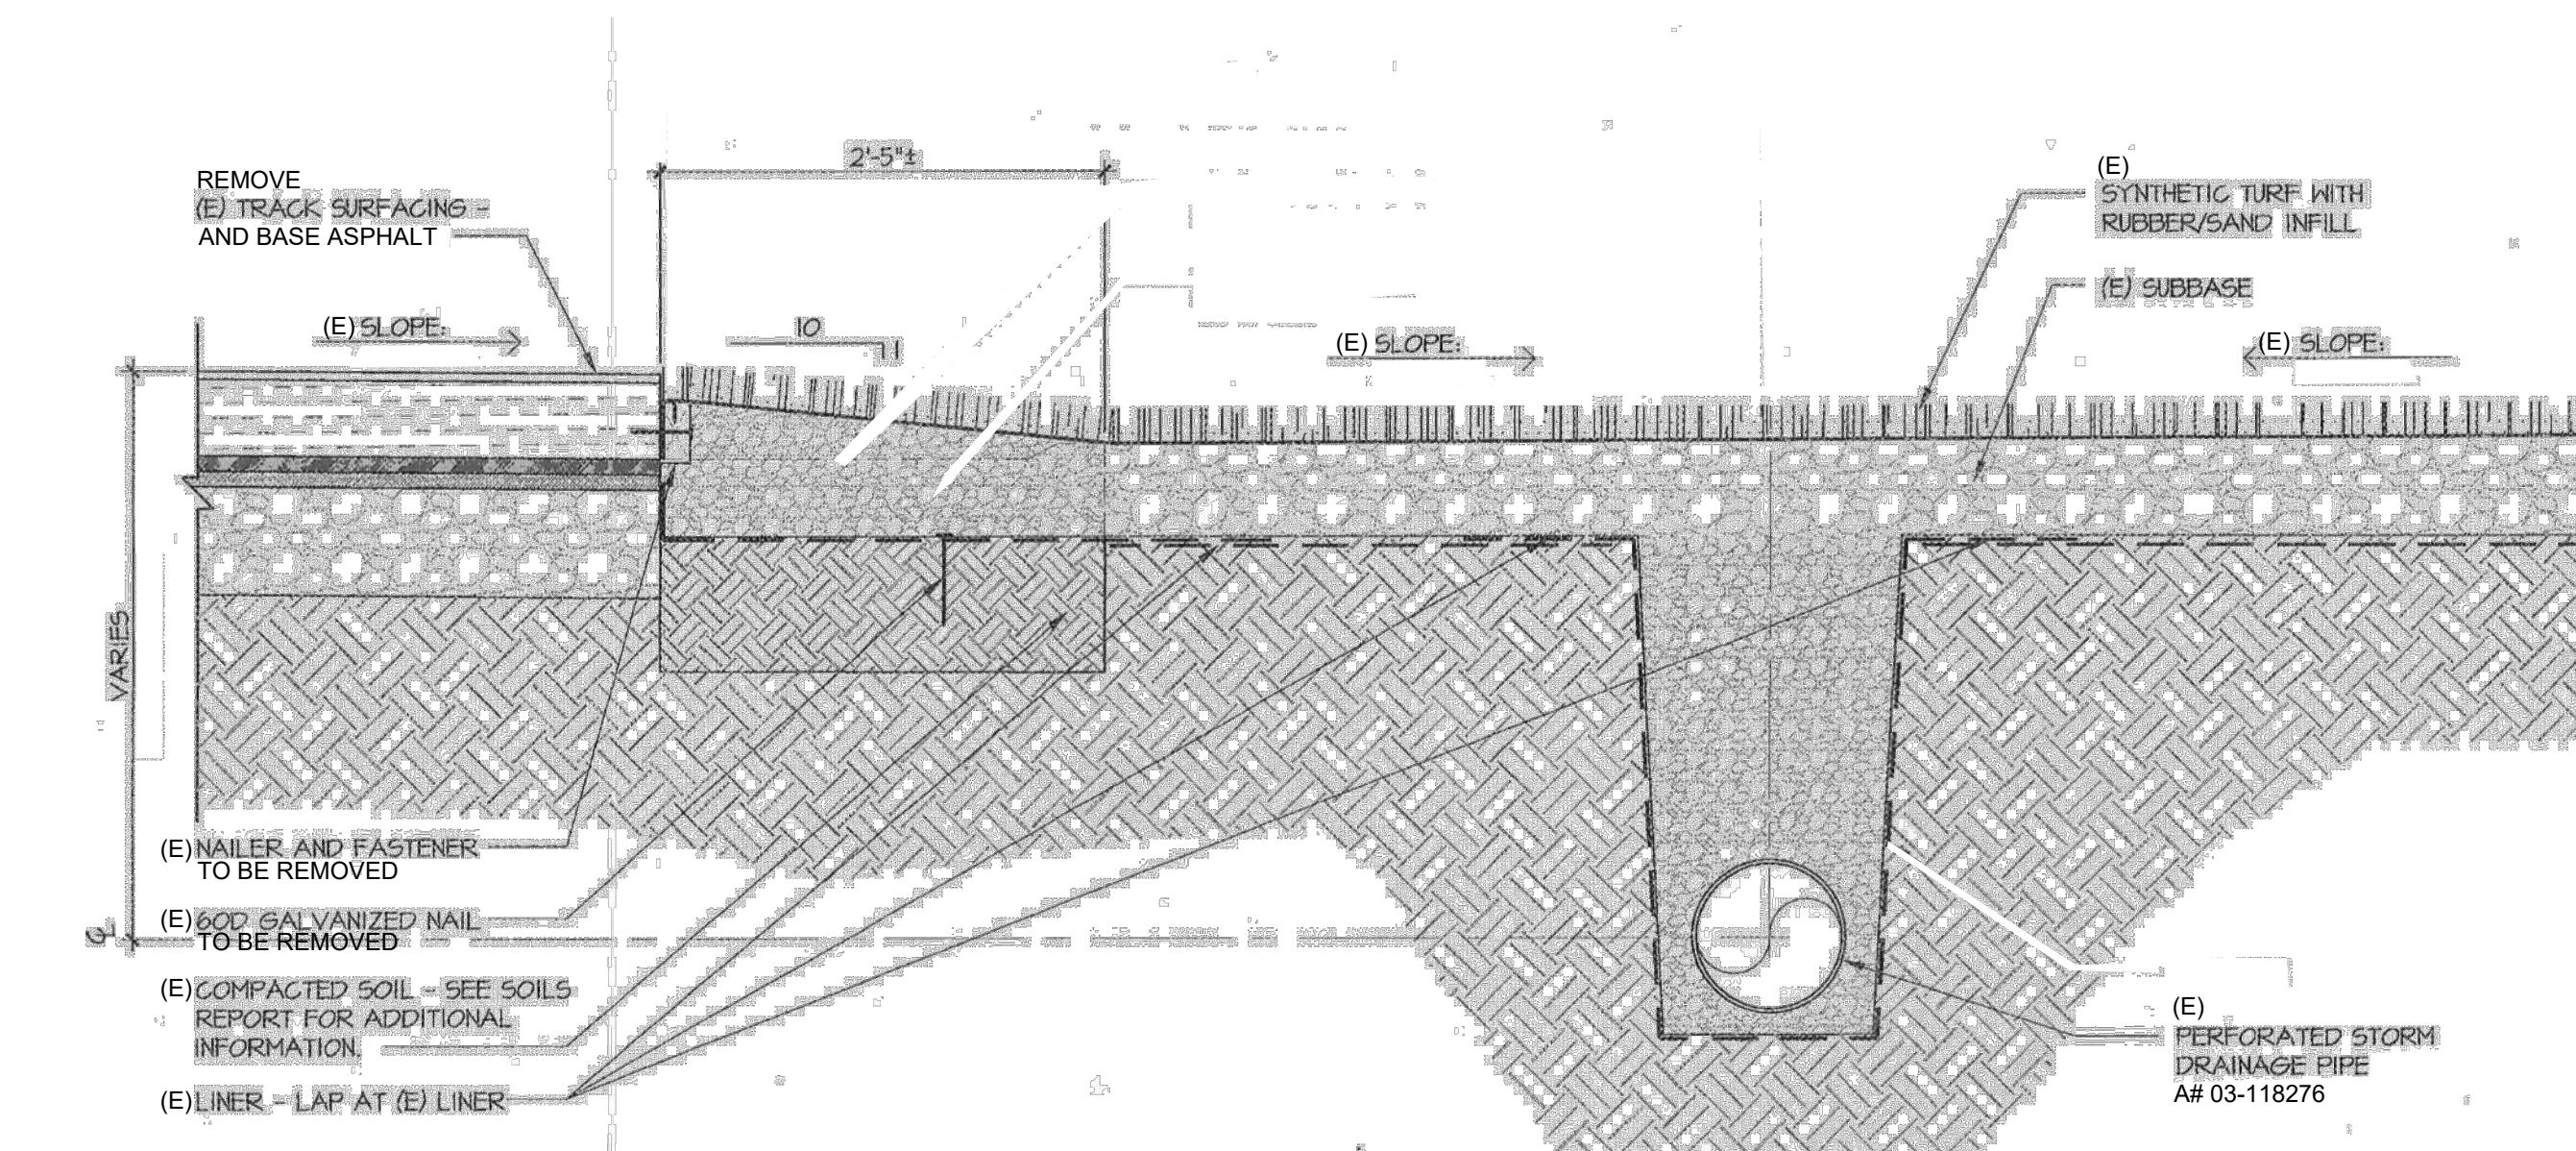


6 SYNTHETIC TURF DETAIL @ STADIUM FIELD/TRACK TRANSITION - DEMOLITION
SCALE: N.T.S.

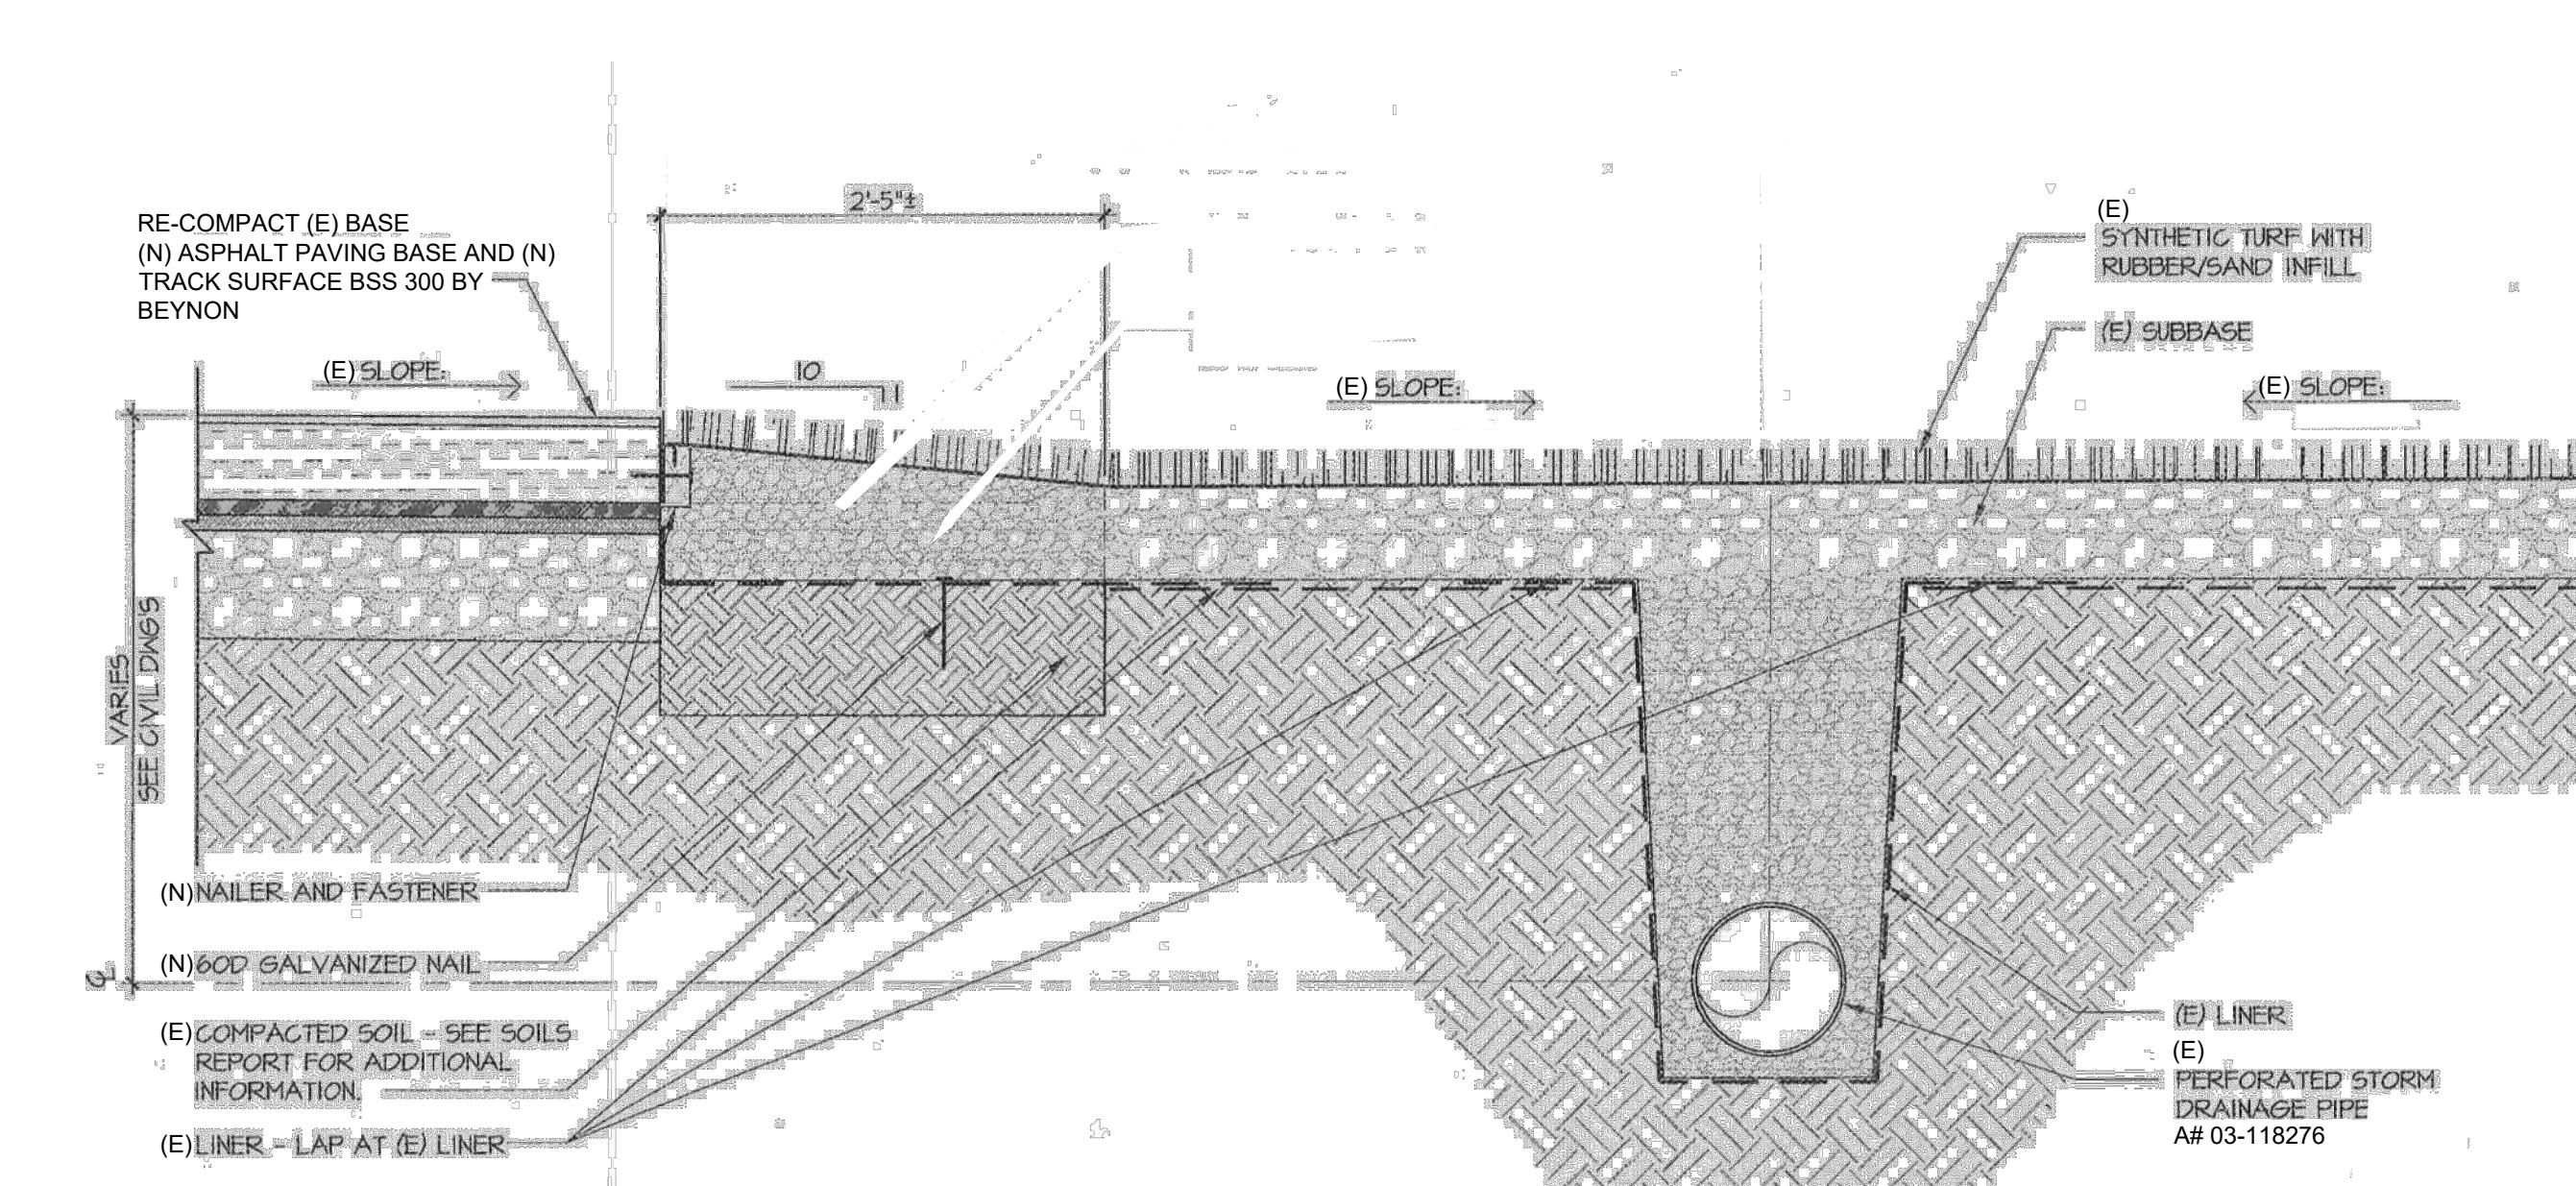

7 SYNTHETIC TURF DETAIL @ STADIUM FIELD/TRACK TRANSITION - NEW
SCALE: N.T.S.

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CONSULTANT:

CONSULTANTS STAMP:

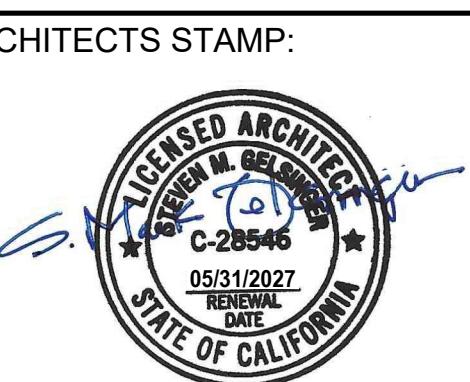SCHOOL DISTRICT:
BONITA UNIFIED SCHOOL DISTRICT

PROJECT:
BONITA HIGH SCHOOL RUNNING TRACK REPLACEMENT

BONITA HIGH SCHOOL
3102 D. STREET
LAVERNE, CA. 91750


JOB NUMBER: 12.01.06
DATE: 3/12/25

REVISION: DATE: _____
REVISION: DATE: _____

DRAWING TITLE:
SITE DETAILS

DRAWING NO.:

A1.5

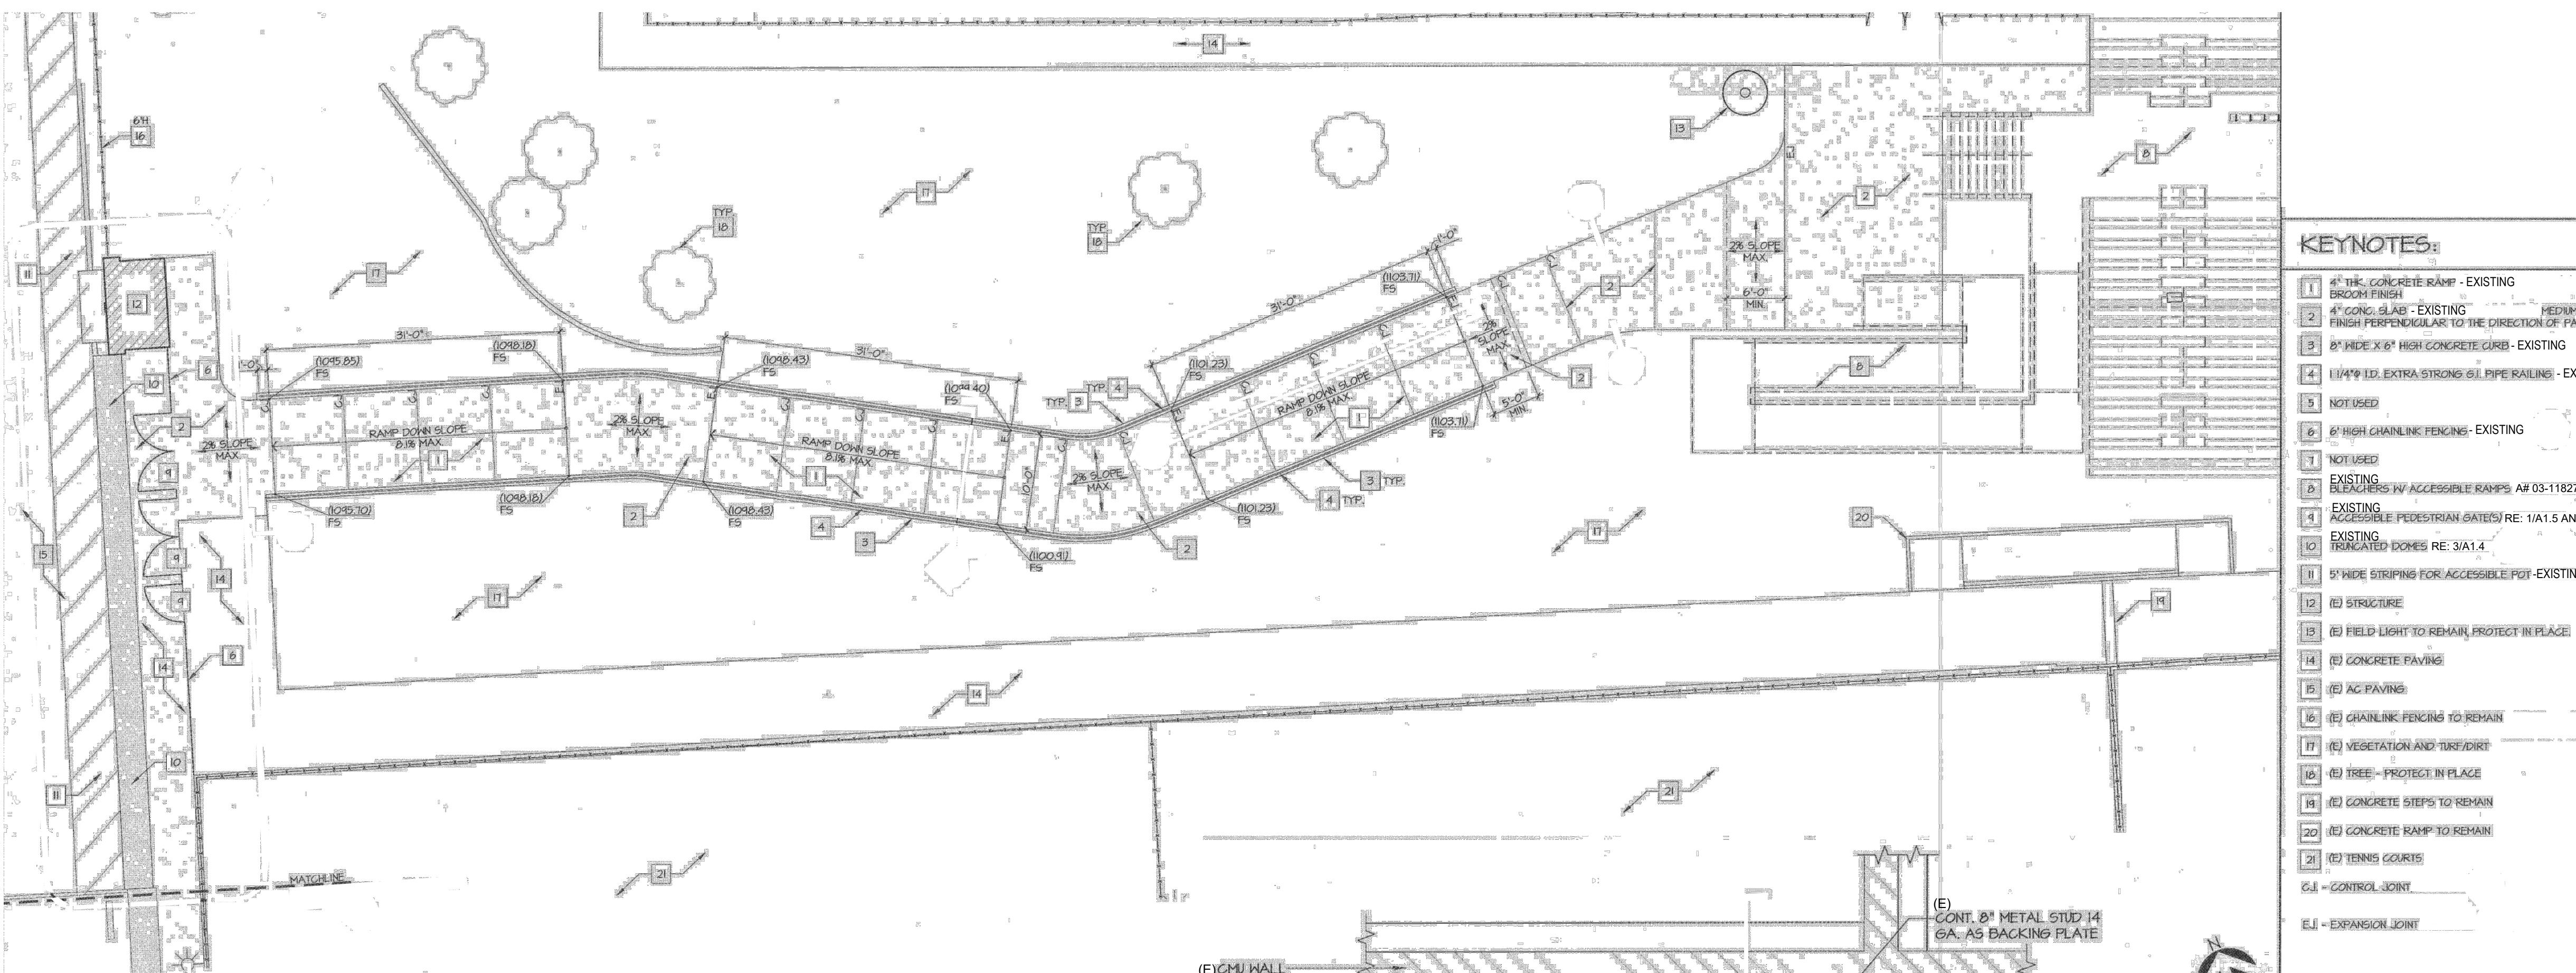


1 EXISTING ENLARGED SITE PLAN @ HOME ENTRANCE

SCALE: N.T.S. 1/AS1.9 A# 03-118276




1/AS1.9 A# 03-118276

276

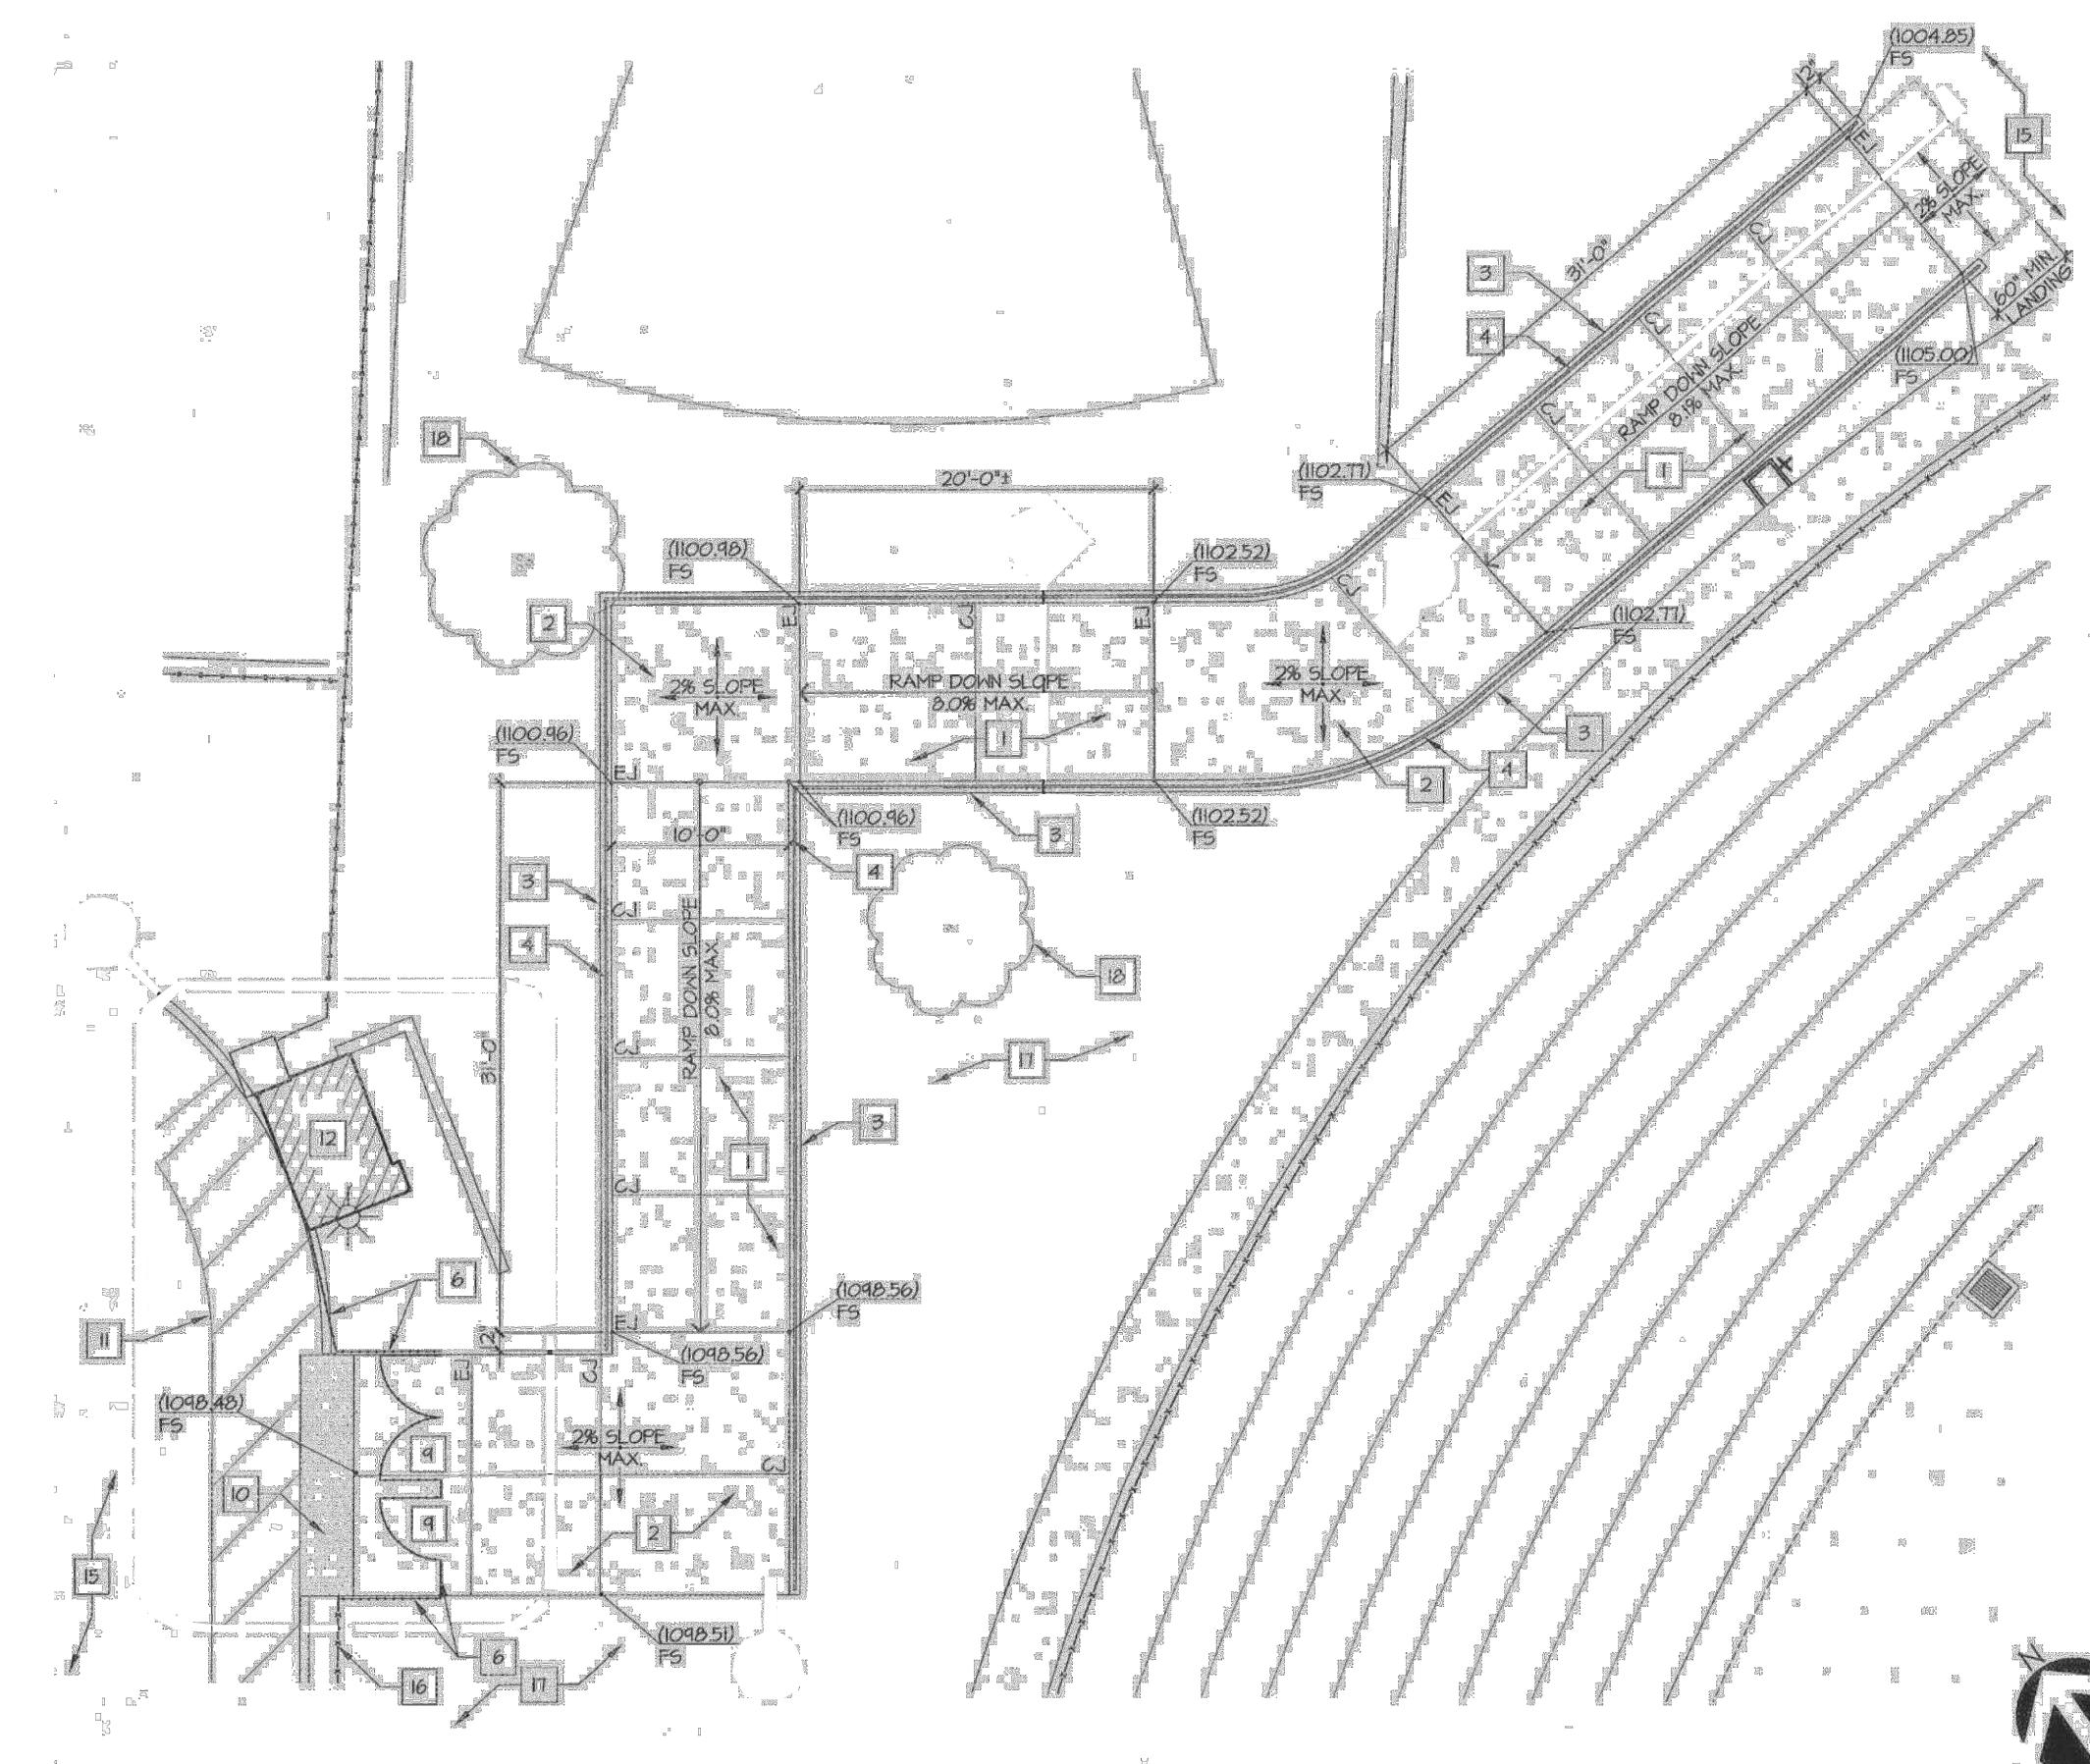

2 EXISTING EXTERIOR RAMP/STAIR PLAN @ VISITOR ENTRANCE
SCALE: N.T.S. 5/AS1.9 A# 03-118276

5/AS1.9 A# 03-118276

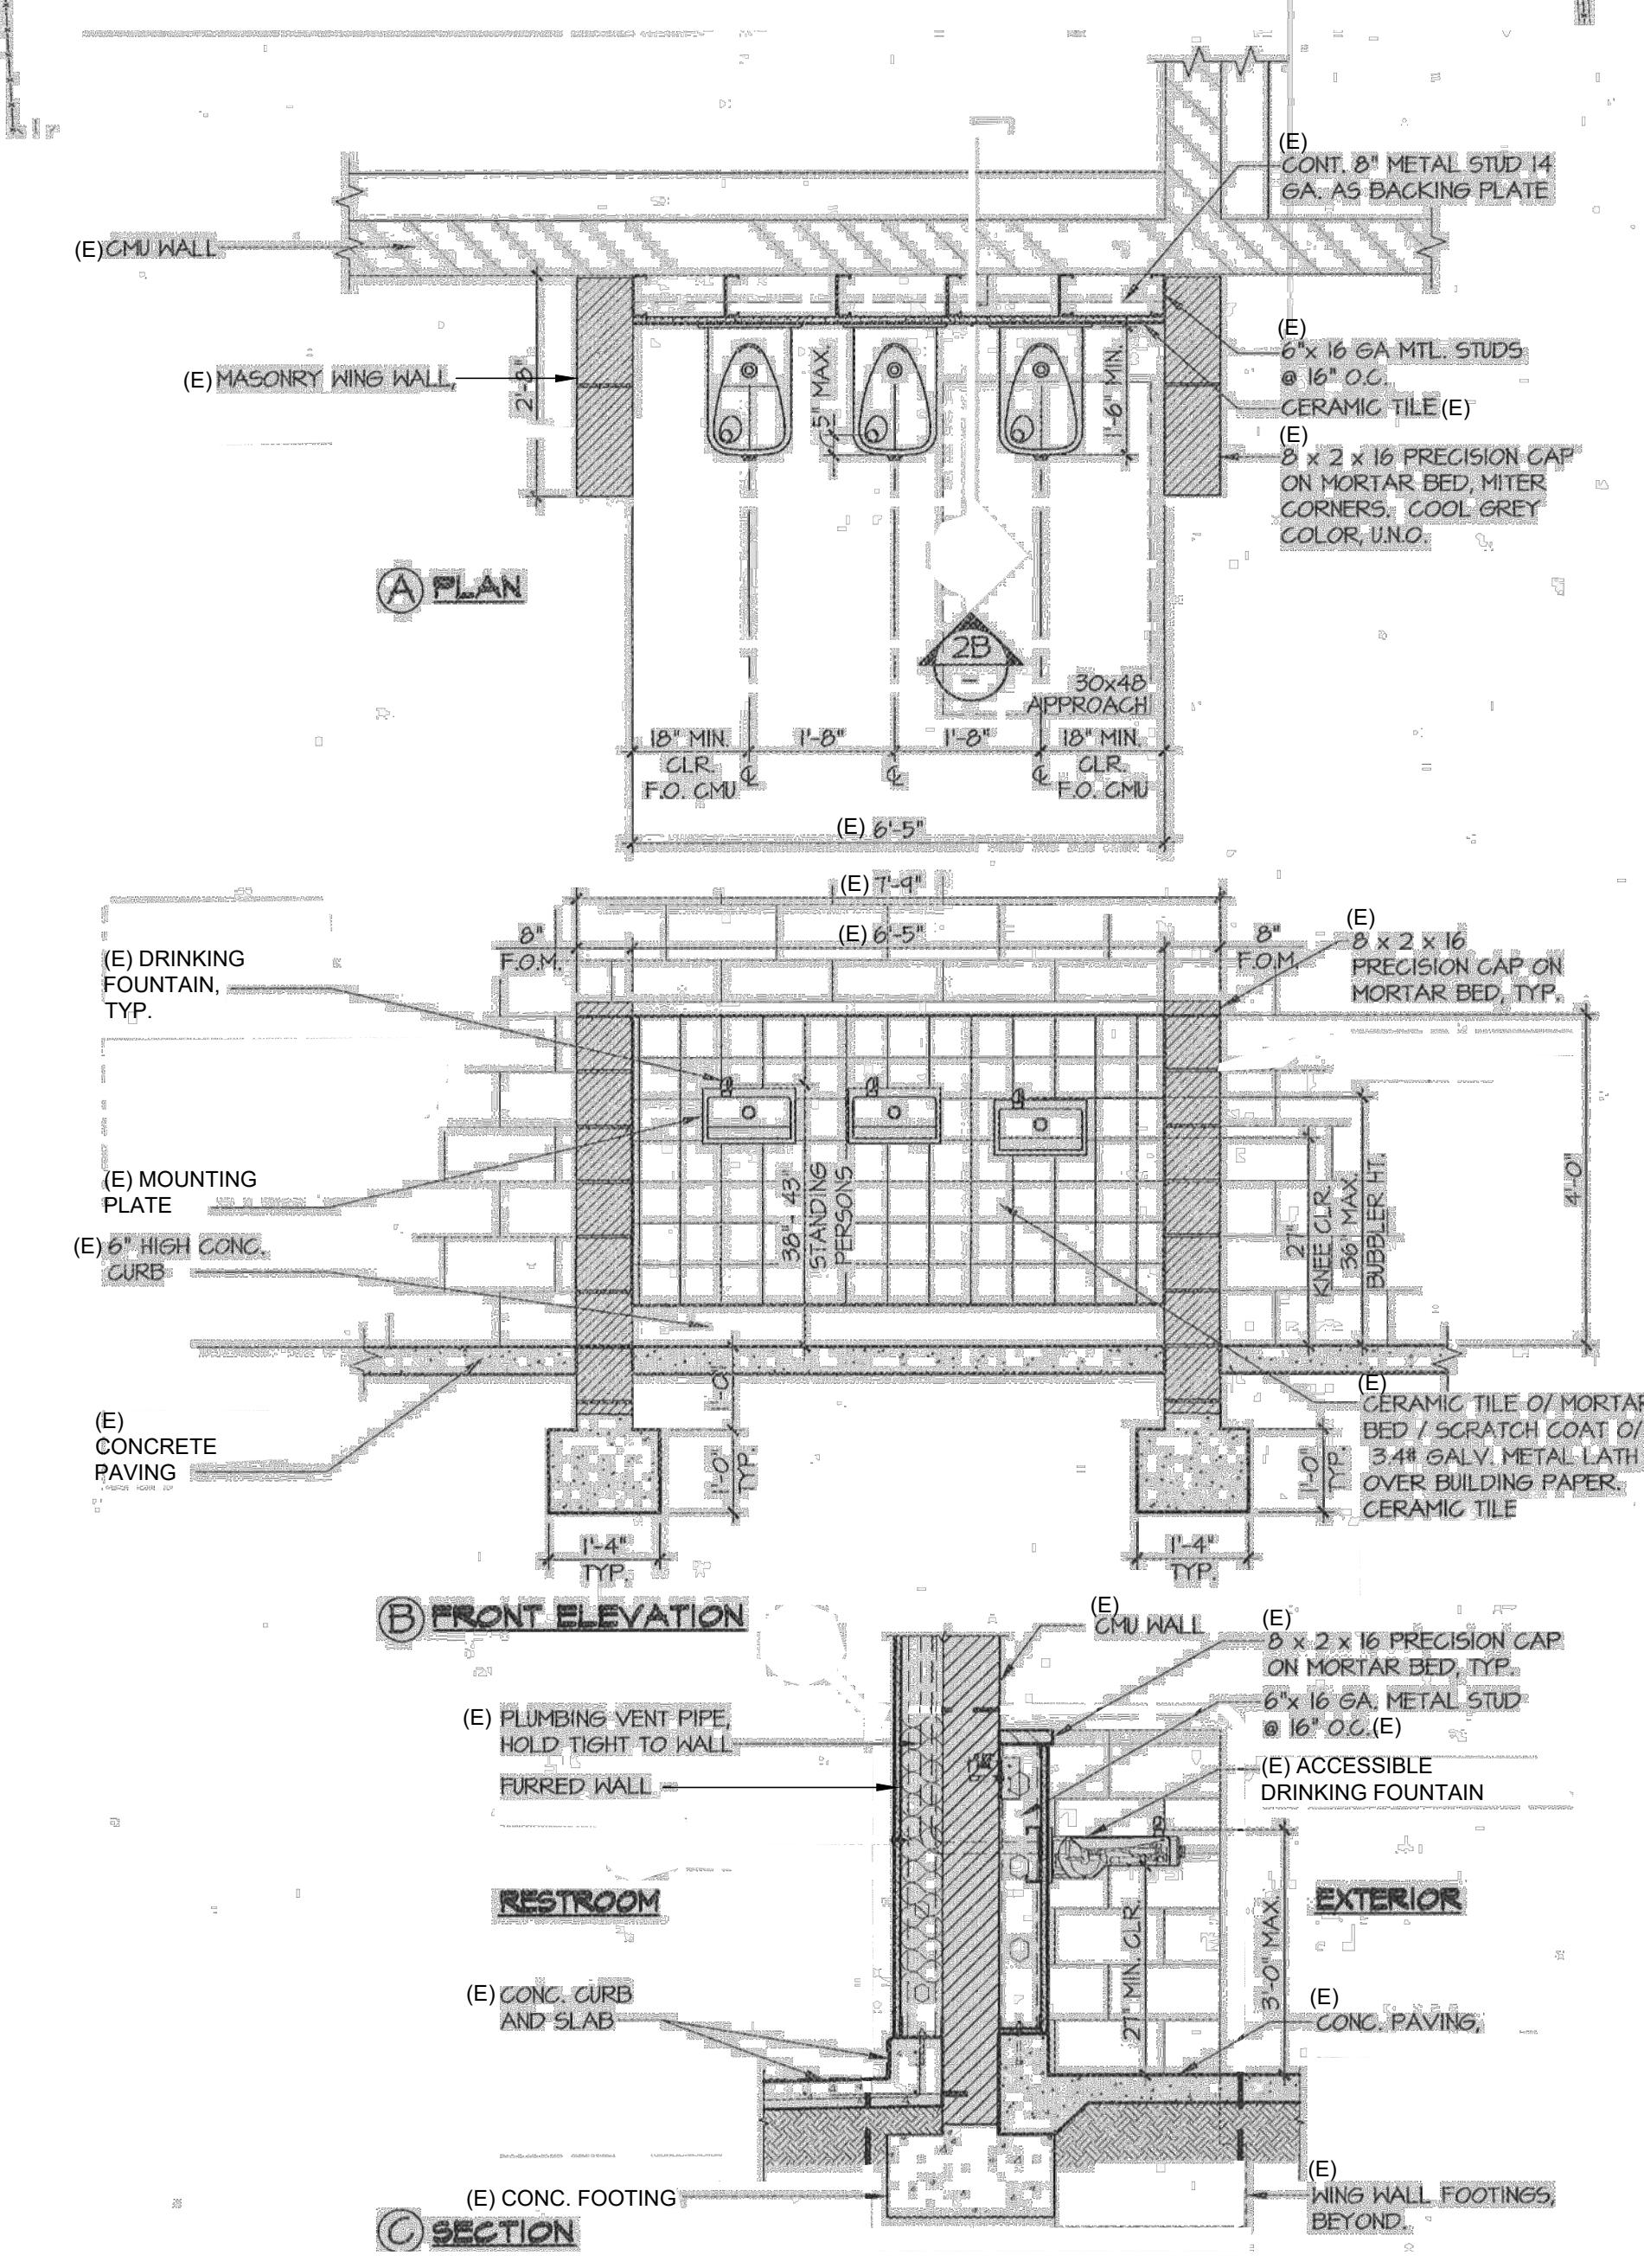

3 (E) ACCESS. D.F. @ (E) TOILET BLDG.
SCALE: N.T.S. 2/A7.1 A# 03-11827

2/A7.1 A# 03-11827

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ARCHITECTS STAMP:



CONSULTANT:

CONSULTANTS STAMP:

SCHOOL DISTRICT:
**BONITA UNIFIED
SCHOOL DISTRICT**

PROJECT: **BONITA HIGH SCHOOL RUNNING TRACK REPLACEMENT**


BONITA HIGH SCHOOL
3102 D. STREET
LAVERNE, CA. 91750

REVISION:  1 DATE: _____
REVISION:  2 DATE: _____

DRAWING TITLE: **SITE DETAILS**

DRAWING NO.:

A1.6

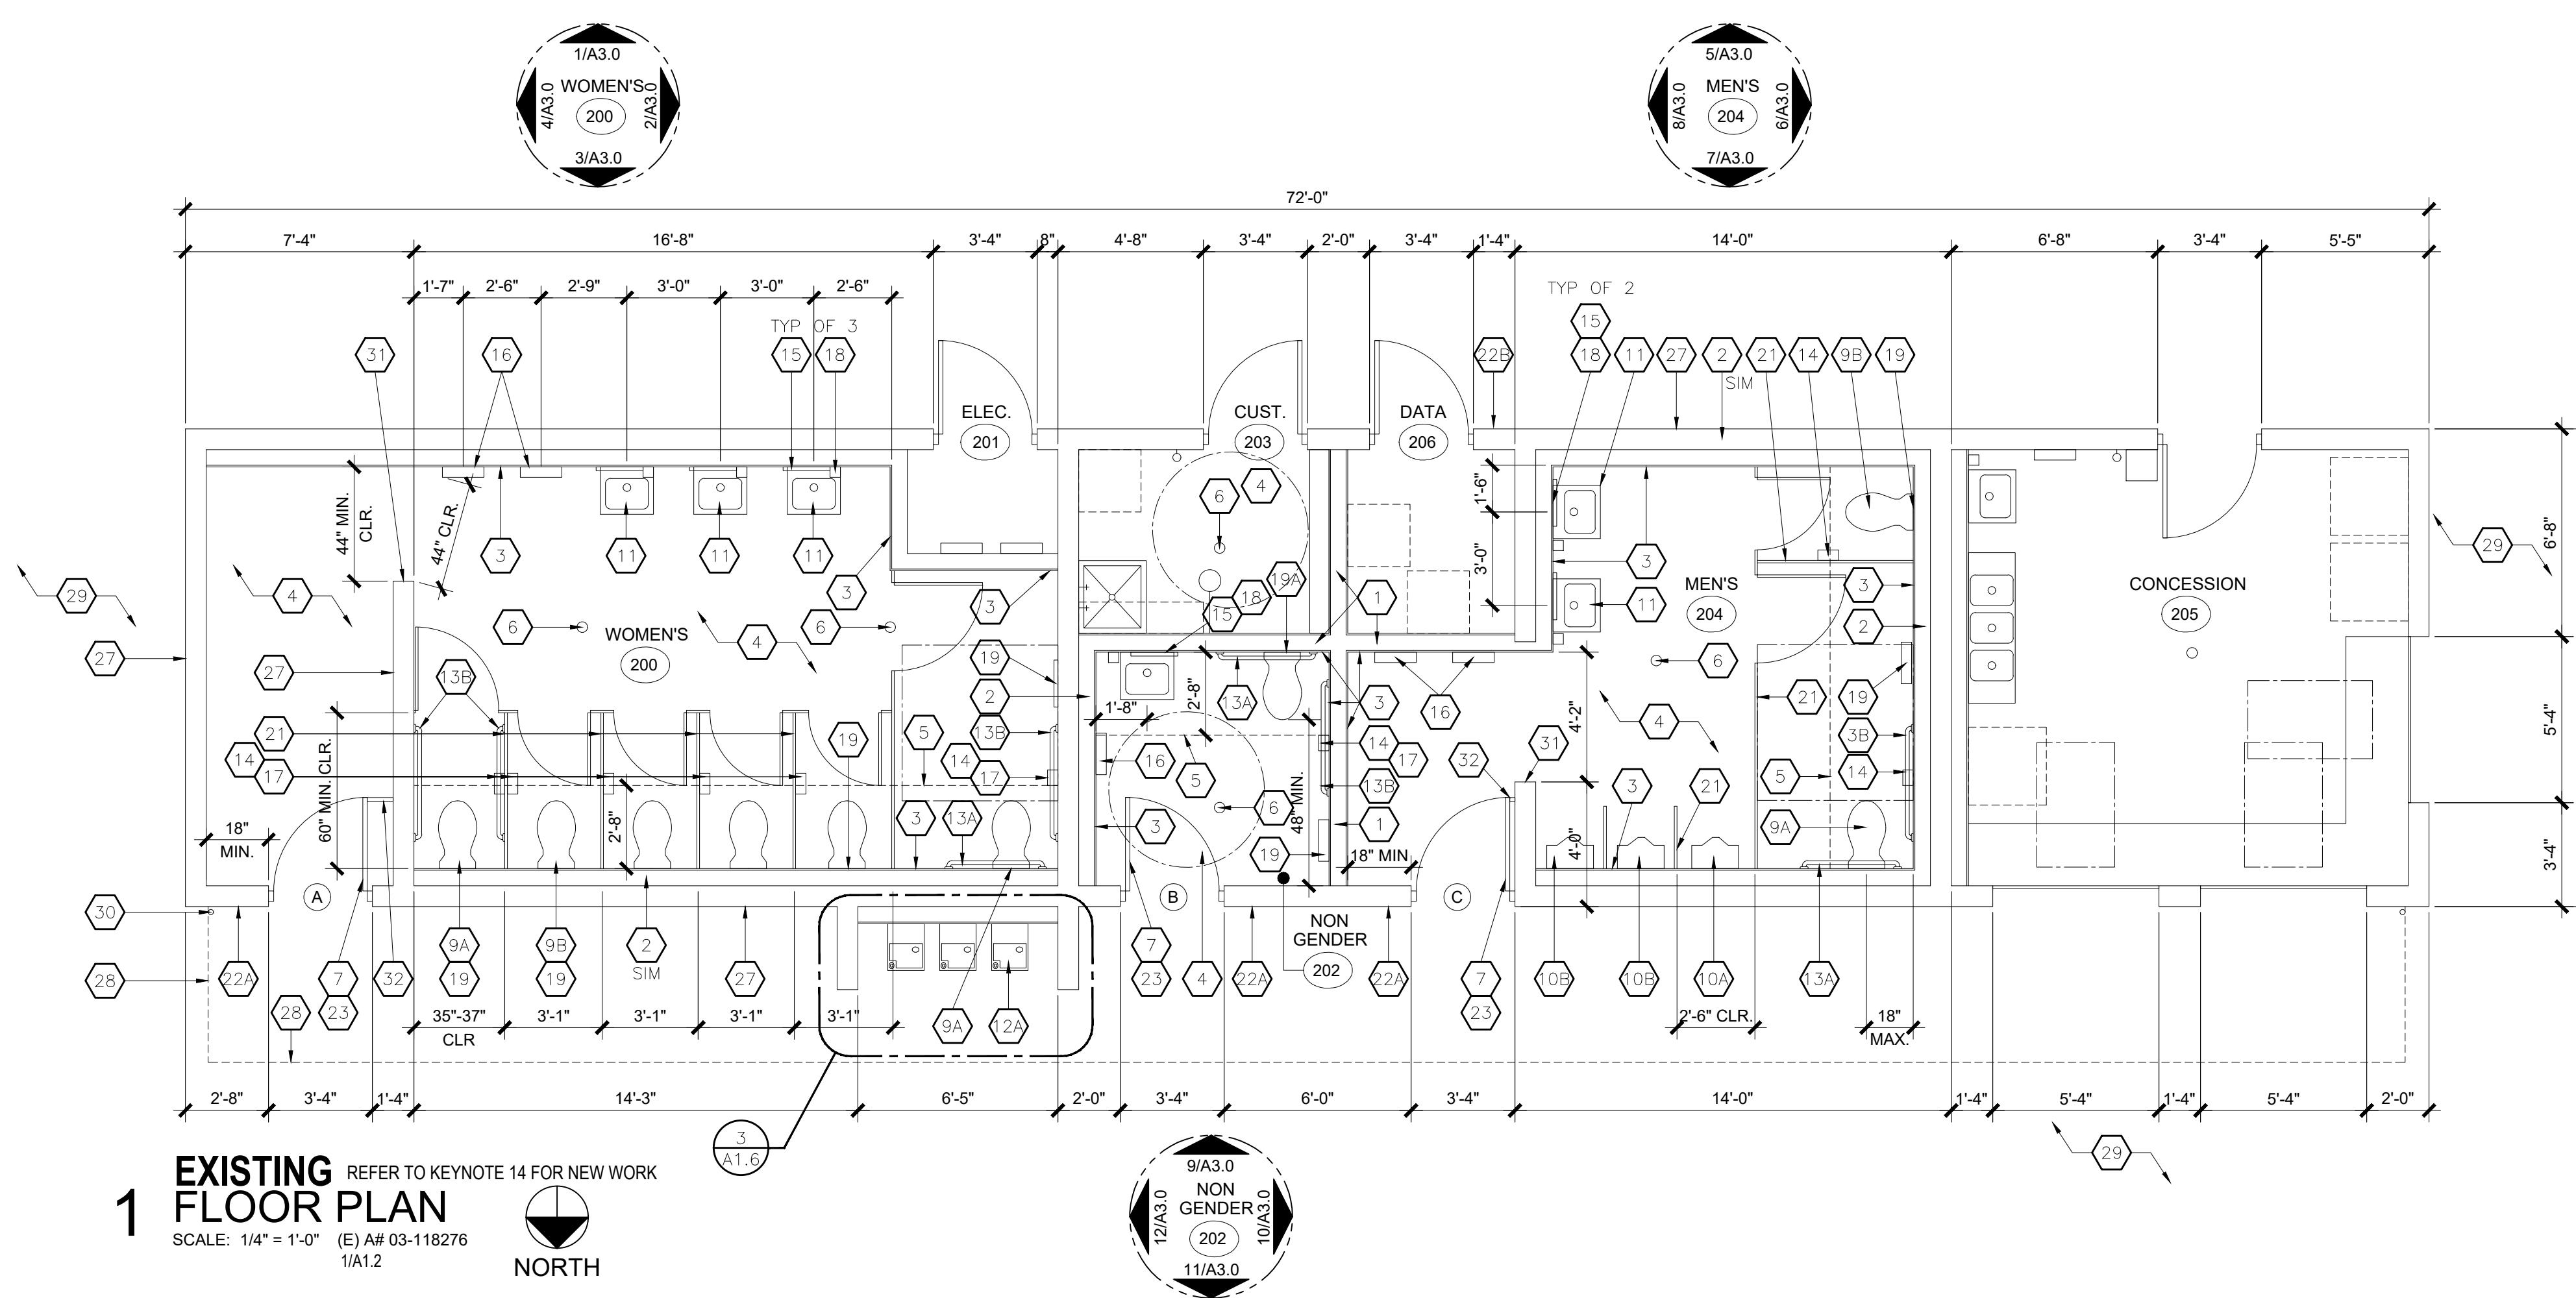


1 EXISTING FLOOR PLAN

REFER TO KEYNOTE 14 FOR NEW WORK

SCALE: 1/4" = 1'-0" (E) A# 03-1182
1/1A.2

1/A1.2

NORT

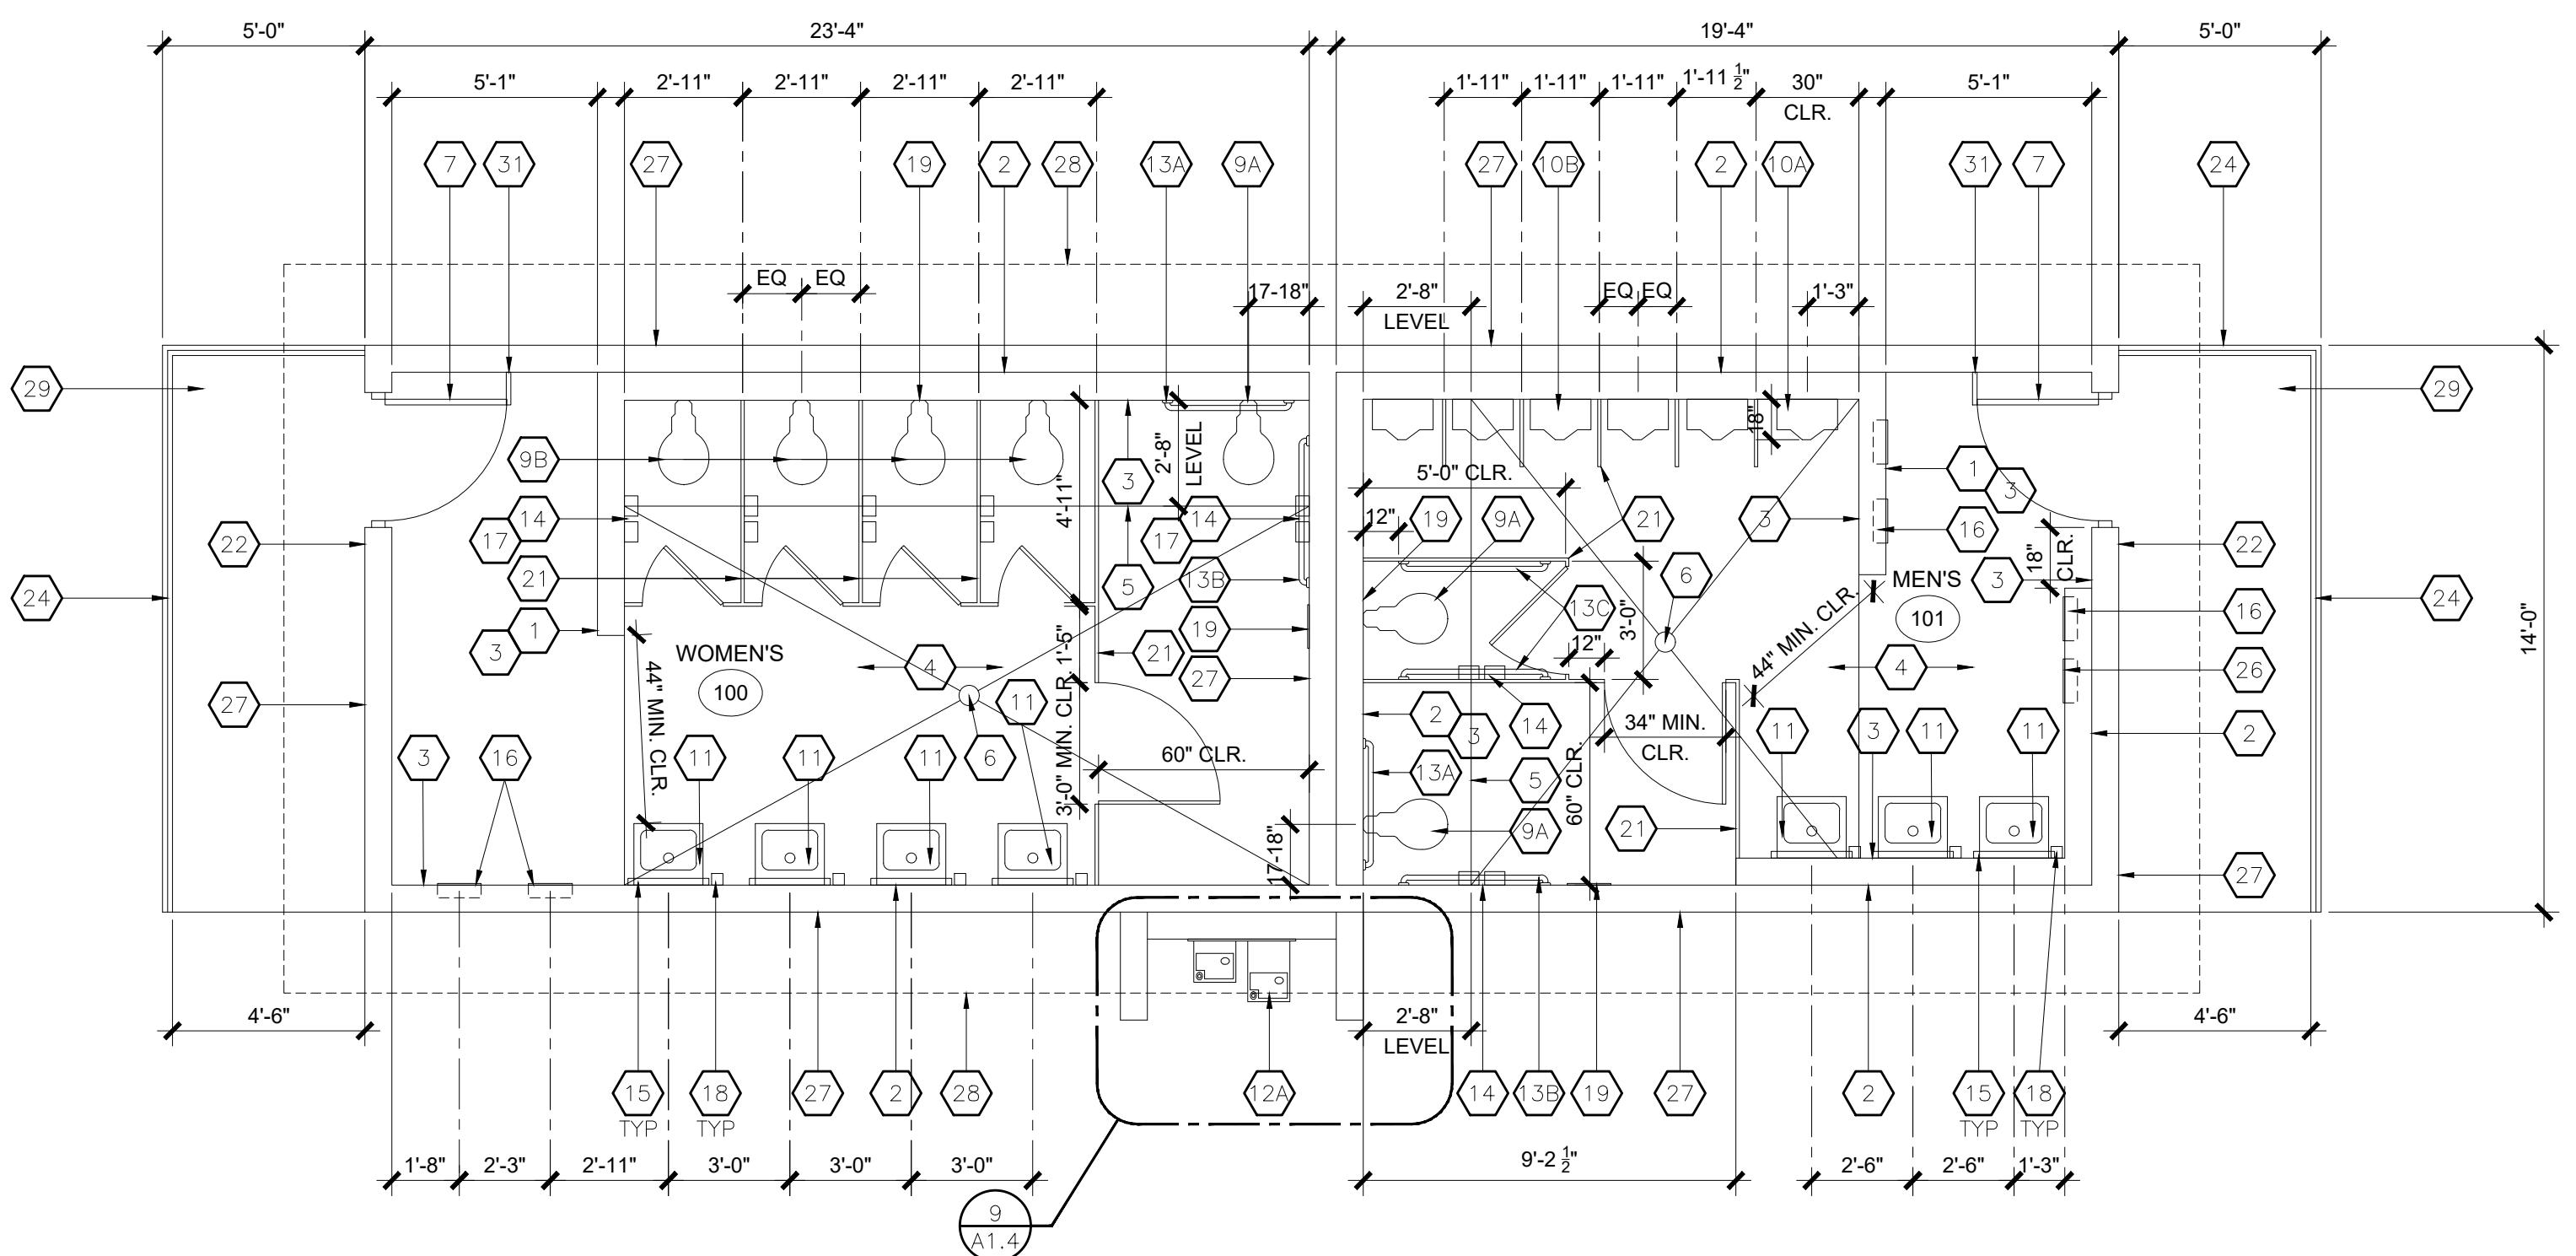

2 EXISTING FLOOR PLAN

REFER TO KEYNOTE 14 FOR NEW WORK



SCALE: 1/4" = 1'-0" (E) A-12-118272

SCALE: 1/4" = 1'-0" (E) A# 03-1182
1/11.1

1/A1.1

NORT

KEYNOTES

1. (E) 6" 20 GA. METAL STUD FRAMED WALL ON 6" HIGH CONC. CURB
2. (E) 6" 20 GA. METAL STUD FURRED WALL ON 6" HIGH CONC. CURB
3. (E) CERAMIC TILE WAINSCOT
4. (E) CONC. FLOOR SLAB W/ SMOOTH FINISH, HARDENER AND EPOXY SEALER WITH A COEFFICIENT OF FRICTION OF AT LEAST 0.42 (DCOF) PER ANSI A137.1
5. (E) LEVEL AREA FOR WATER CLOSET
6. (E) FLOOR DRAIN W/ 2% MAX SLOPE TO GRATE W/ 1/2" MAX. OPENING
7. (E) DOOR
8. (E) WALL MOUNTED FIRE EXTINGUISHER TYP., MOUNTED AT 48: A.F.F. TO HANDLE
- 9A. (E) ACCESSIBLE WATER CLOSET
- 9B. (E) STANDARD WATER CLOSET
- 10A. (E) ACCESSIBLE URINAL
- 10B. (E) STANDARD URINAL
11. (E) ACCESSIBLE LAVATORY W/ INSULATED PIPE JACKET
- 12A. (E) ACCESSIBLE DRINKING FOUNTAIN
- 12B. (E) FLOOR MOUNTED MOP SINK
- 12C. (E) EYEWASH STATION
- 12D. (E) WATER HEATER
- 13A. (E) 36" LONG GRAB BAR
- 13B. (E) 48" LONG GRAB BAR
14. (N) SMI-RECESSED TOILET TISSUE DISPENSER, BOBRICK MODEL 3888
15. (E) FRAMELESS 18" X 30" S.S. MIRROR
16. (E) SURFACE MOUNTED HAND DRYER
17. (E) SANITARY NAPKIN DISPOSAL
18. (E) SURFACE MOUNTED SOAP DISPENSER
19. (E) SURFACE MOUNTED TOILET SEAT COVER DISPENSER
20. (E) SINGLE COLUMN 6 DOOR LOCKER
21. (E) TOILET PARTITION
- 22A. (E) RESTROOM NAME SIGNAGE, RE: A6.0
- 22B. (E) ROOM NAME & NAME PLAQUE W/ ACCESSIBILITY SYMBOL (U.N.O.)
23. (E) DOOR ACCESSIBILITY SIGNAGE, RE: A6.0
24. (E) CASEWORK
25. (E) 36" W. X 8" D. METAL UTILITY SHELF W/ MOP HANGER
26. NOT USED
27. (E) 8" CMU WALL
28. (E) LINE OF ROOF ABOVE
29. (E) CONCRETE WALKWAY / PAVING
30. (E) DOWNSPOUTS
31. (E) CLOSER END BLOCK AT EXPOSED EDGES
32. (E) GATE LOCK IN OPEN POSITION BAR, NOT TO EXCEED 3" PROTECTION

NOTE:
RE: A6.0 FOR DOOR HARDWARE AND SIGNAGE

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CONSULTANT:

CONSULTANTS STAMP:

CHOOL DISTRICT:
**BONITA UNIFIED
SCHOOL DISTRICT**

PROJECT: **BONITA HIGH SCHOOL RUNNING TRACK REPLACEMENT**


BONITA HIGH SCHOOL
3102 D. STREET
LAVERNE, CA. 91750

DATE: 3/12/25

**DRAWING TITLE:
FLOOR PLAN**


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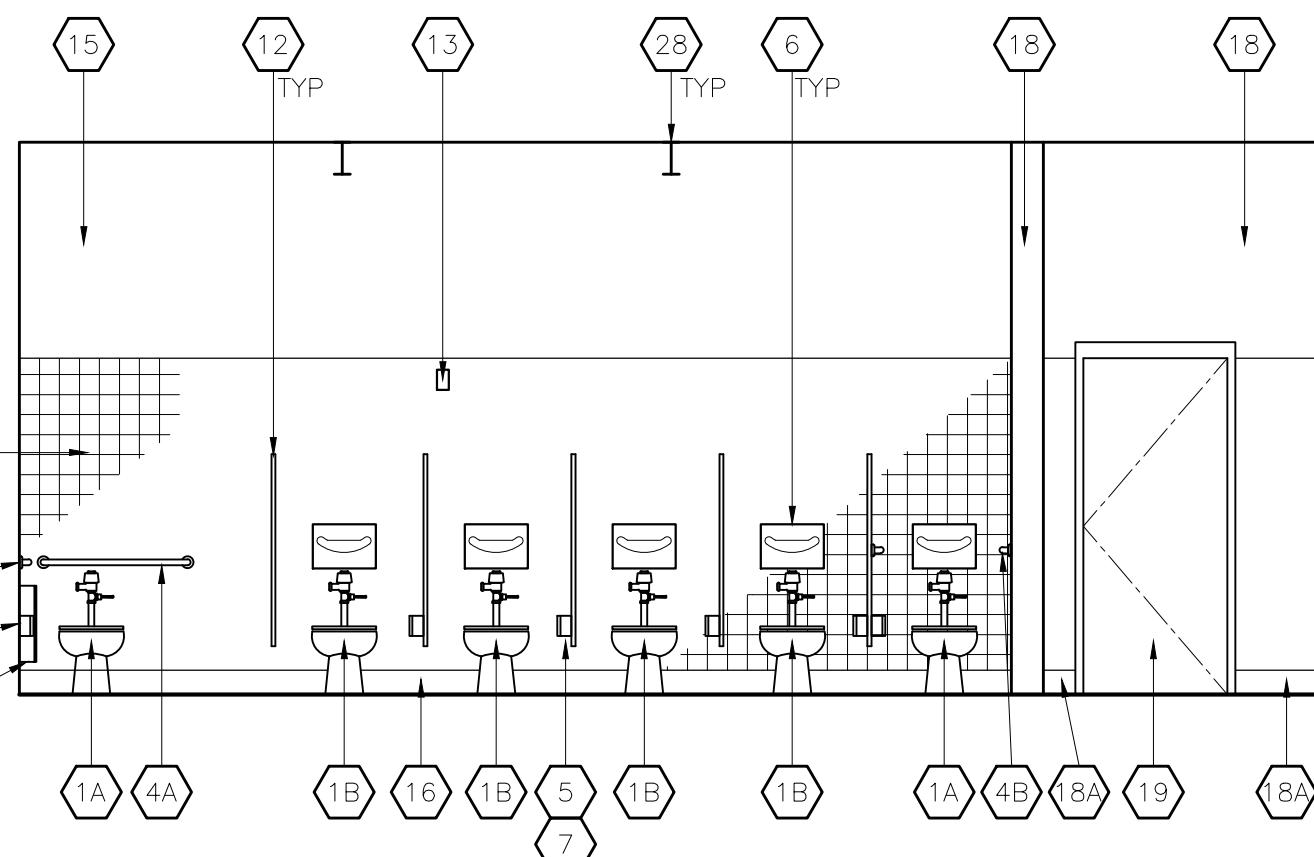
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SCALE: 1/4" = 1'-0"
A# 03-118276 1/A6.2

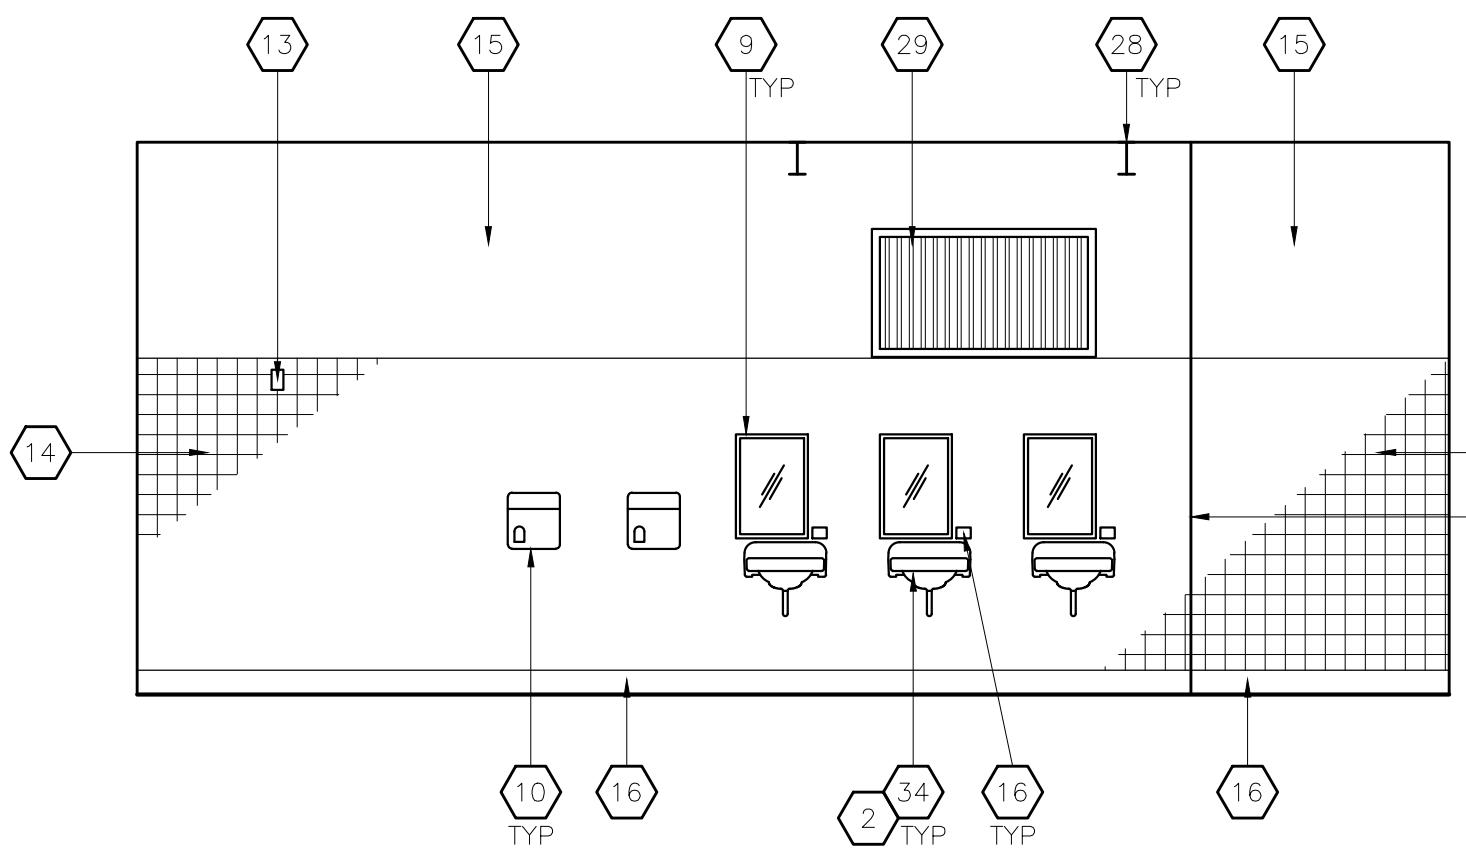


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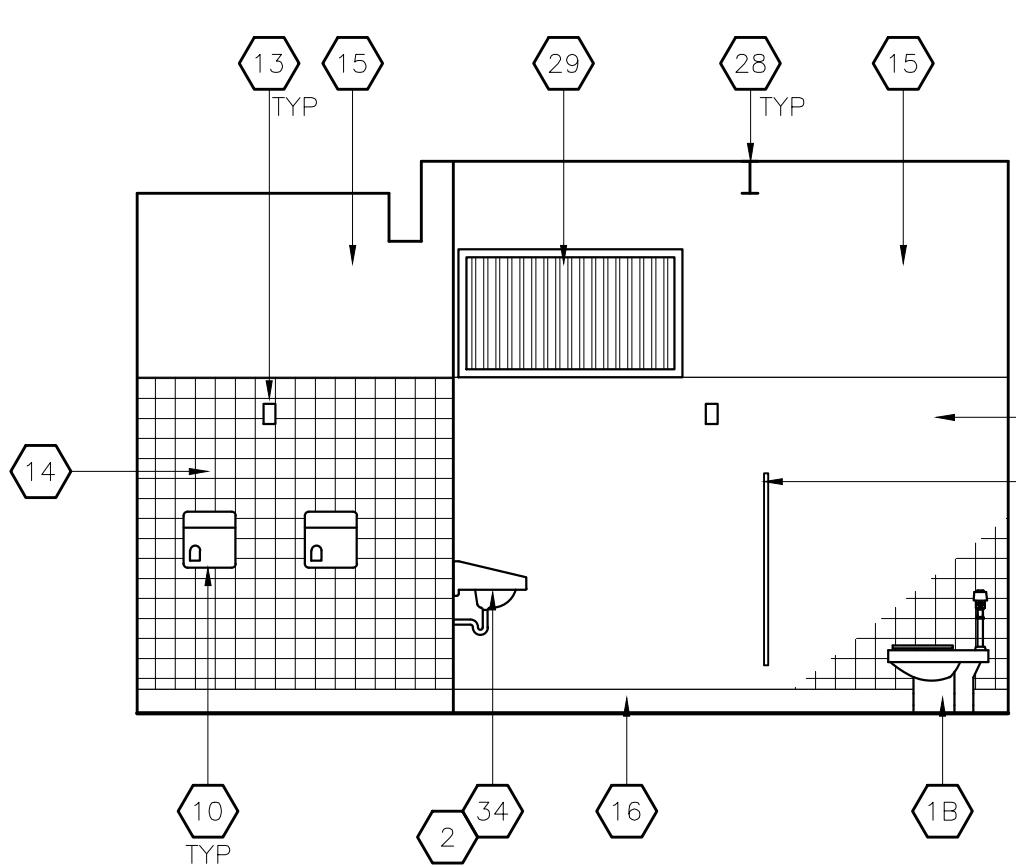
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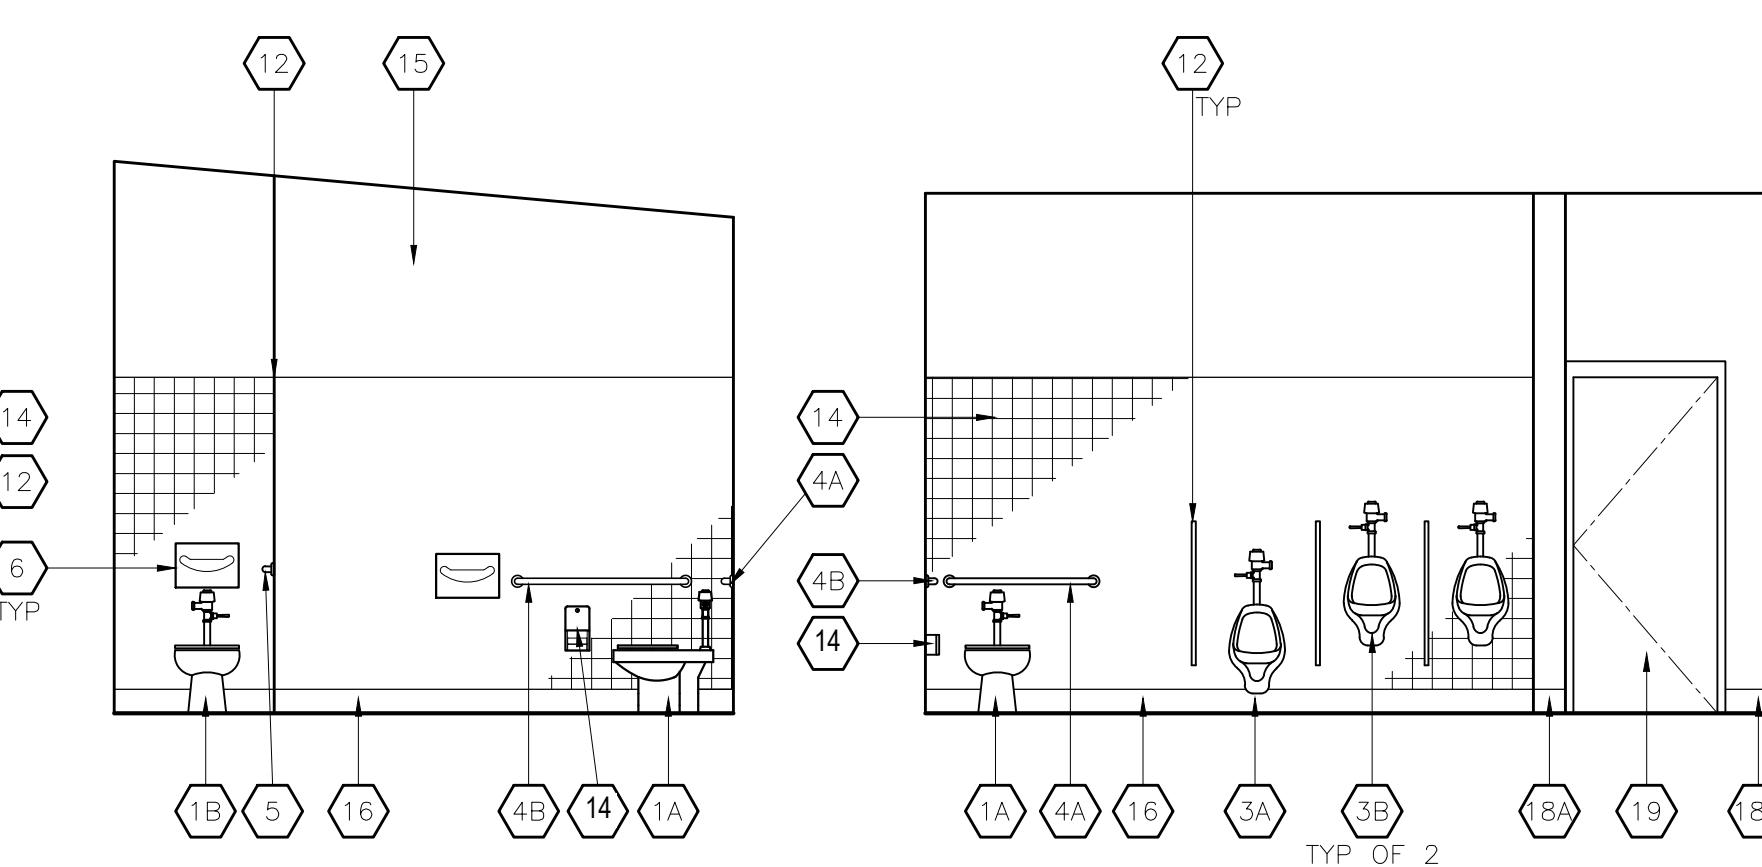
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SCALE: 1/4" = 1'-0"
A# 03-118276 1/A6.2




5 EXISTING INT. ELEV.

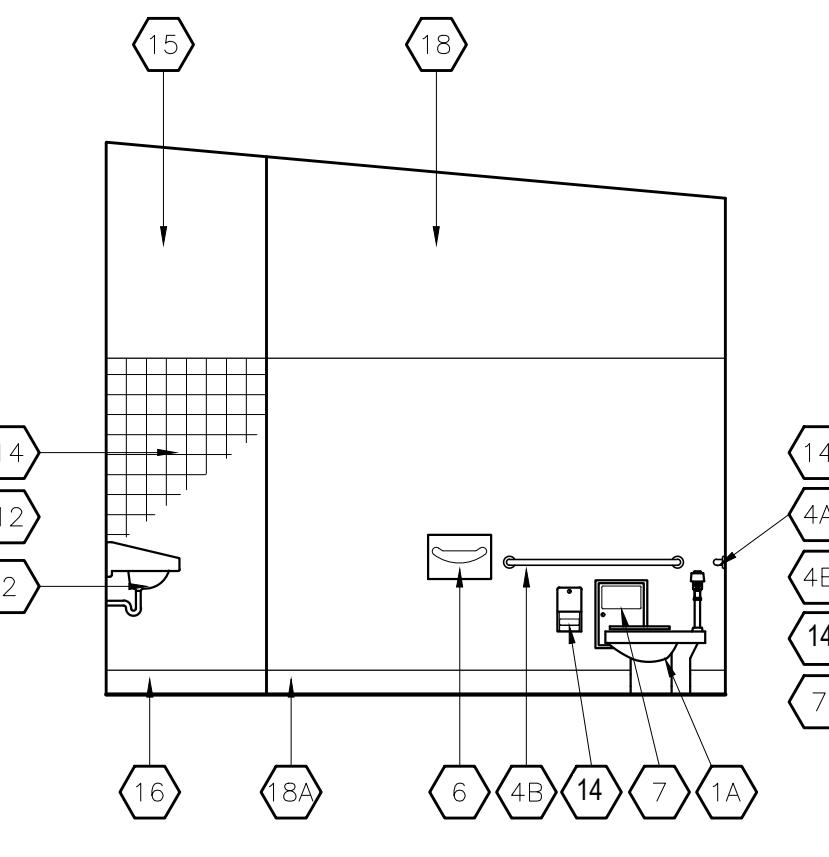SCALE: 1/4" = 1'-0"
A# 03-118276 2/A6.2

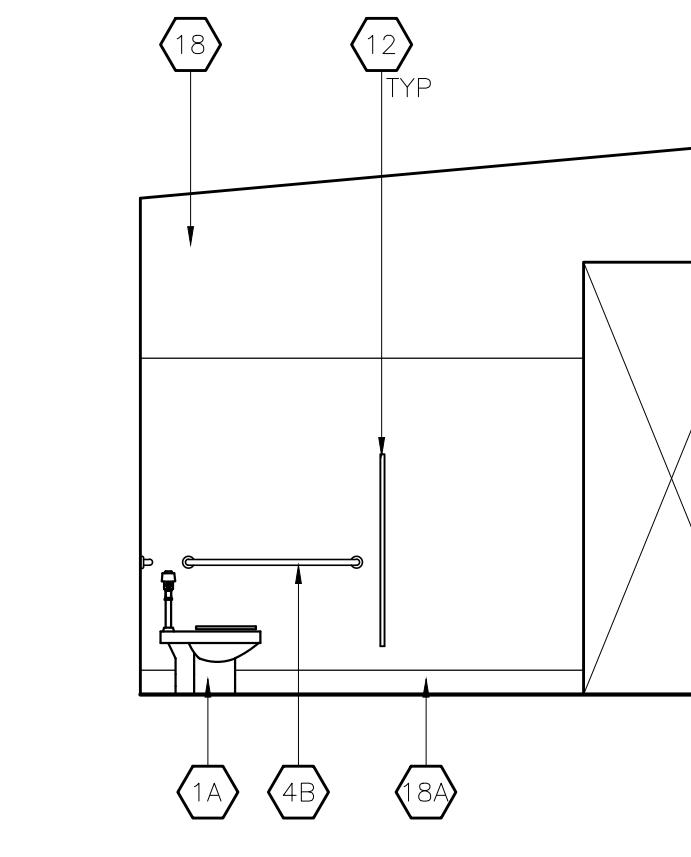


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SCALE: 1/4" = 1'-0"
A# 03-118276 2/A6.2

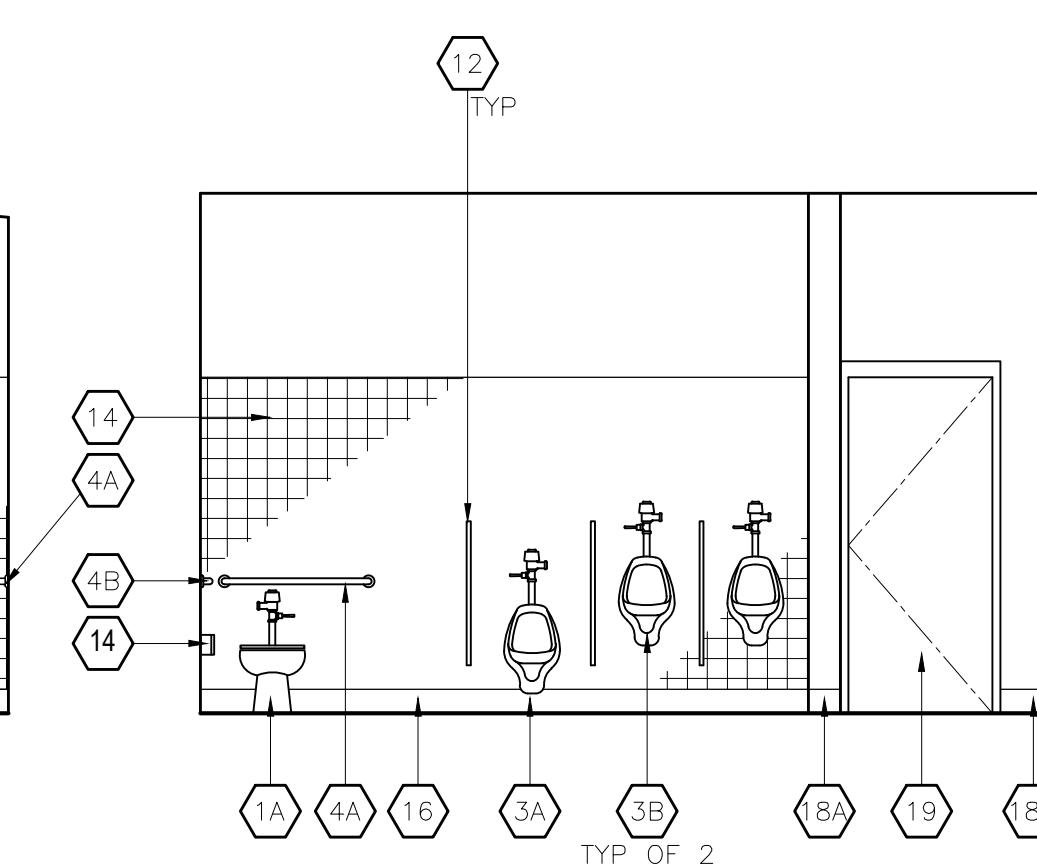


7 EXISTING INT. ELEV.

SCALE: 1/4" = 1'-0"
A# 03-118276 2/A6.2

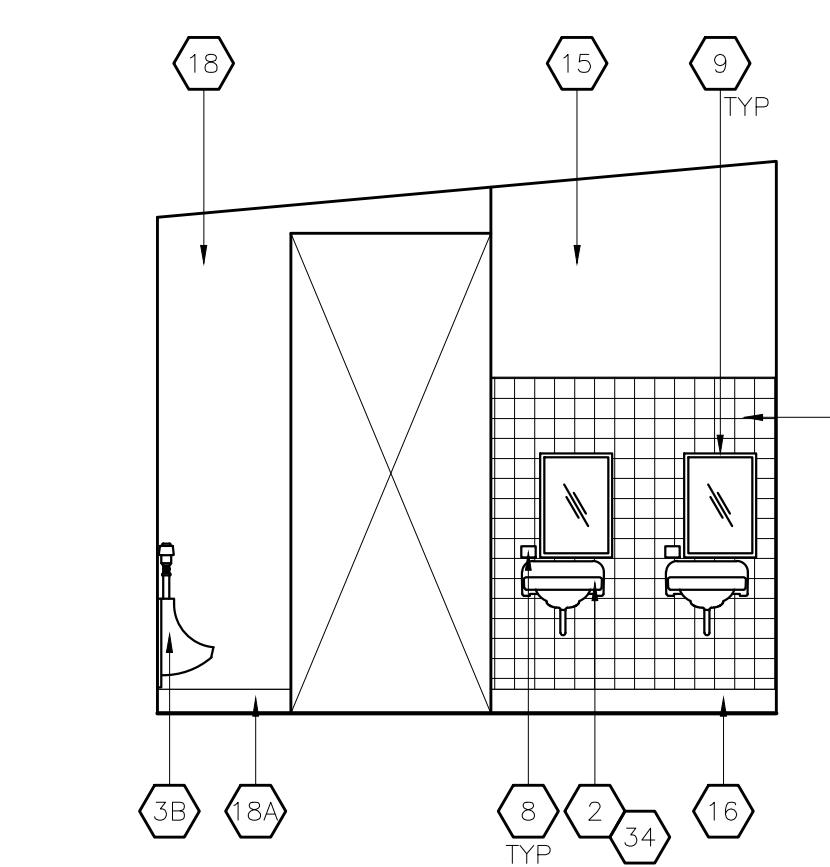


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A# 03-118276 2/A6.2

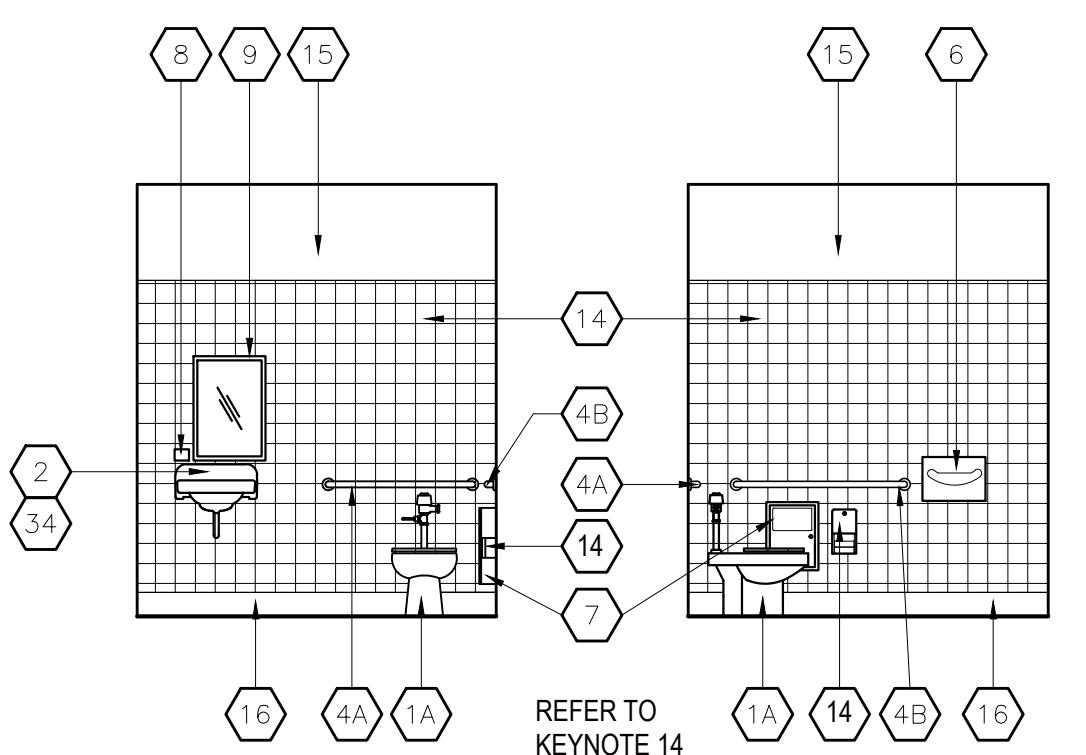


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SCALE: 1/4" = 1'-0"
A# 03-118276 3/A6.2




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A# 03-118276 3/A6.2

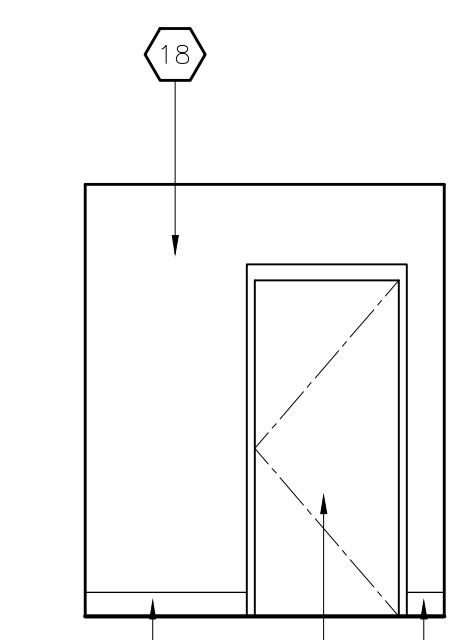


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SCALE: 1/4" = 1'-0"
A# 03-118276 3/A6.2

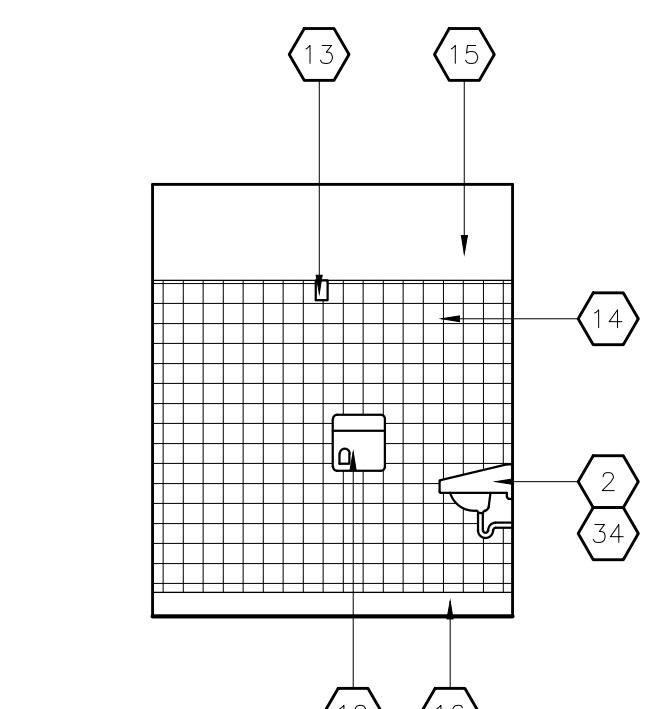


12 EXISTING INT. ELEV.

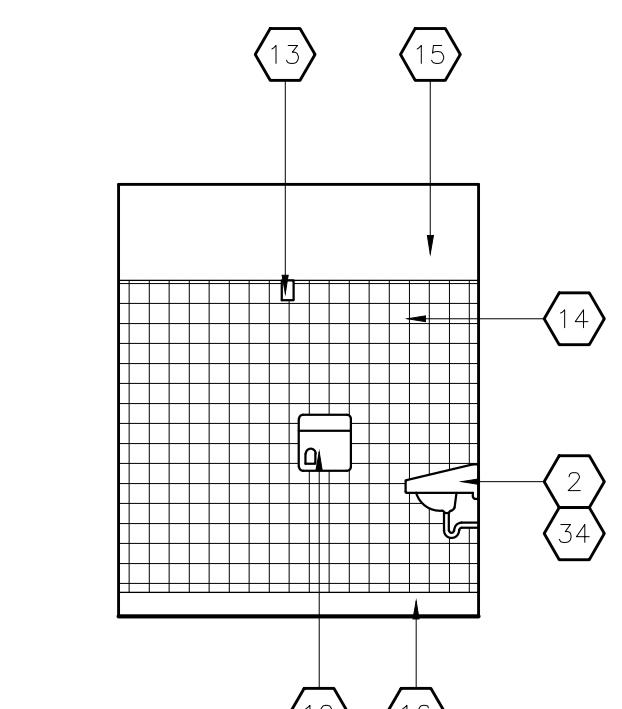SCALE: 1/4" = 1'-0"
A# 03-118276 3/A6.2

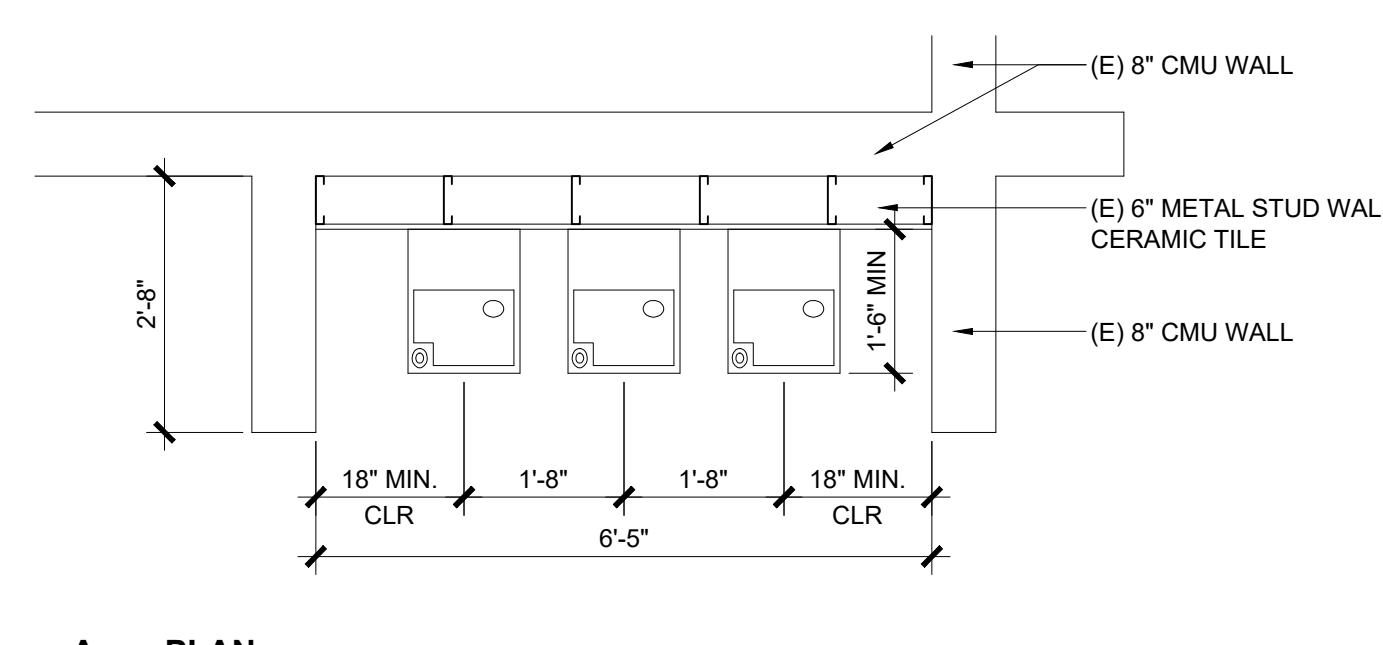

A. PLAN

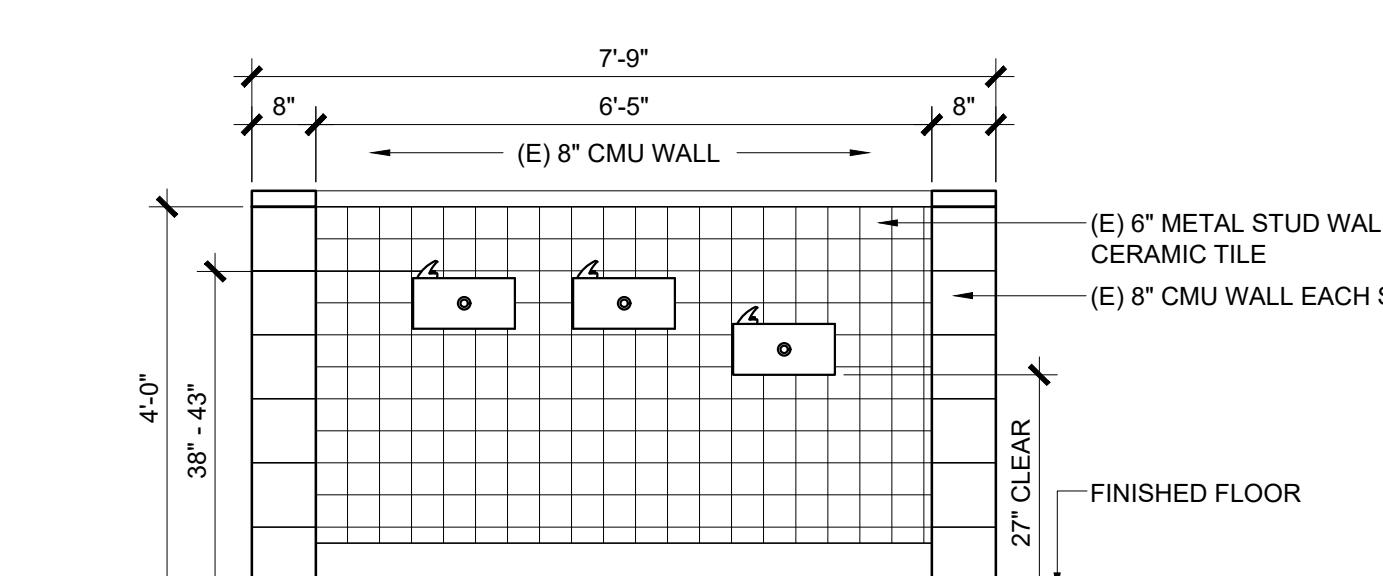

B. ELEVATION EXISTING DRINKING FOUNTAIN

SCALE: 1/2" = 1'-0"
(E) A# 03-118276 2/A7.1

KEYNOTES ◊

- (E) 6" 20 GA. METAL STUD FRAMED WALL ON 6" HIGH CONC. CURB
- (E) 6" 20 GA. METAL STUD FRAMED WALL ON 6" HIGH CONC. CURB
- (E) CERAMIC TILE WAISNCOT
- (E) CONCRETE SLAB W/ SMOOTH FINISH, HARDENER AND EPOXY SEALER WITH A COEFFICIENT OF FRICTION OF AT LEAST 0.42 (DCOF) PER ANSI A137.1
- (E) LEVEL AREA FOR WATER CLOSET
- (E) FLOOR DRAIN W/ 2% MAX SLOPE TO GRATE W/ 1/2" MAX. OPENING
- (E) DOOR
- (E) WALL MOUNTED FIRE EXTINGUISHER TYP., MOUNTED AT 48: A.F.F. TO HANDLE
- (E) ACCESSIBLE WATER CLOSET
- (E) STANDARD WATER CLOSET
- (E) ACCESSIBLE URINAL
- (E) STANDARD URINAL
- (E) ACCESSIBLE LAVATORY W/ INSULATED PIPE JACKET
- (E) ACCESSIBLE DRINKING FOUNTAIN
- (E) FLOOR MOUNTED MOP SINK
- (E) EYEWASH STATION
- (E) WATER HEATER
- (E) 36" LONG GRAB BAR
- (E) 48" LONG GRAB BAR
- (N) SMI-RECESSED TOILET TISSUE DISPENSER, BOBRICK MODEL 3888
- (E) FRAMELESS 18" X 30" S.S. MIRROR
- (E) SURFACE MOUNTED HAND DRYER
- (E) SANITARY NAPKIN DISPOSAL
- (E) SURFACE MOUNTED SOAP DISPENSER
- (E) SURFACE MOUNTED TOILET SEAT COVER DISPENSER
- (E) SINGLESPLIT 6 DOOR LOCKER
- (E) TOILET PARTITION
- (E) RESTROOM NAME SIGNAGE
- (E) ROOM NAME & NAME PLAQUE W/ ACCESSIBILITY SYMBOL (U.N.O.)
- (E) DOOR ACCESSIBILITY SIGNAGE
- (E) CASEWORK
- (E) 36" W. X 8" D. METAL UTILITY SHELF W/ MOP HANGER NOT USED
- (E) 8" CMU WALL
- (E) LINE OF ROOF ABOVE
- (E) CONCRETE WALKWAY / PAVING
- (E) DOWNSPOUTS
- (E) CLOSER END BLOCK AT EXPOSED EDGES
- (E) GATE LOCK IN OPEN POSITION BAR, NOT TO EXCEED 3" PROTECTION
- (E) NOT USED
- (E) ACCESSIBLE HAND SINK

REFER TO A3.0A FOR MOUNTING HEIGHTS

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CONSULTANT:

CONSULTANTS STAMP:

SCHOOL DISTRICT:
BONITA UNIFIED SCHOOL DISTRICT

PROJECT:
BONITA HIGH SCHOOL RUNNING TRACK REPLACEMENT

BONITA HIGH SCHOOL
3102 D. STREET
LAVERNE, CA 91750

JOB NUMBER: 12.01.06
DATE: 3/12/25

REVISION: 1 DATE: _____
REVISION: 2 DATE: _____


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INTERIOR ELEVATIONS

DRAWING NO.:

A3.0




STANDARD FIXTURES HEIGHT DIMENSIONS		ADULT
1.	TOILET SEAT HEIGHT / DIMENSIONS TO TOP OF SEAT	15"
2.	TOILET PAPER IN FRONT OF TOILET	12"
3.	NOT USED	
4.	DISPENSER OR MIRROR HEIGHT	40"
5.	LAVATORY / SINK TOP HEIGHT	34"
6.	URINAL LIP HEIGHT	24"
7.	URINAL FLUSH HANDLE HEIGHT	44"
8.	TOILET PAPER DISPENSER HEIGHT	30"
9.	DRINKING FOUNTAIN BUBBLER HEIGHT	39" - 42"

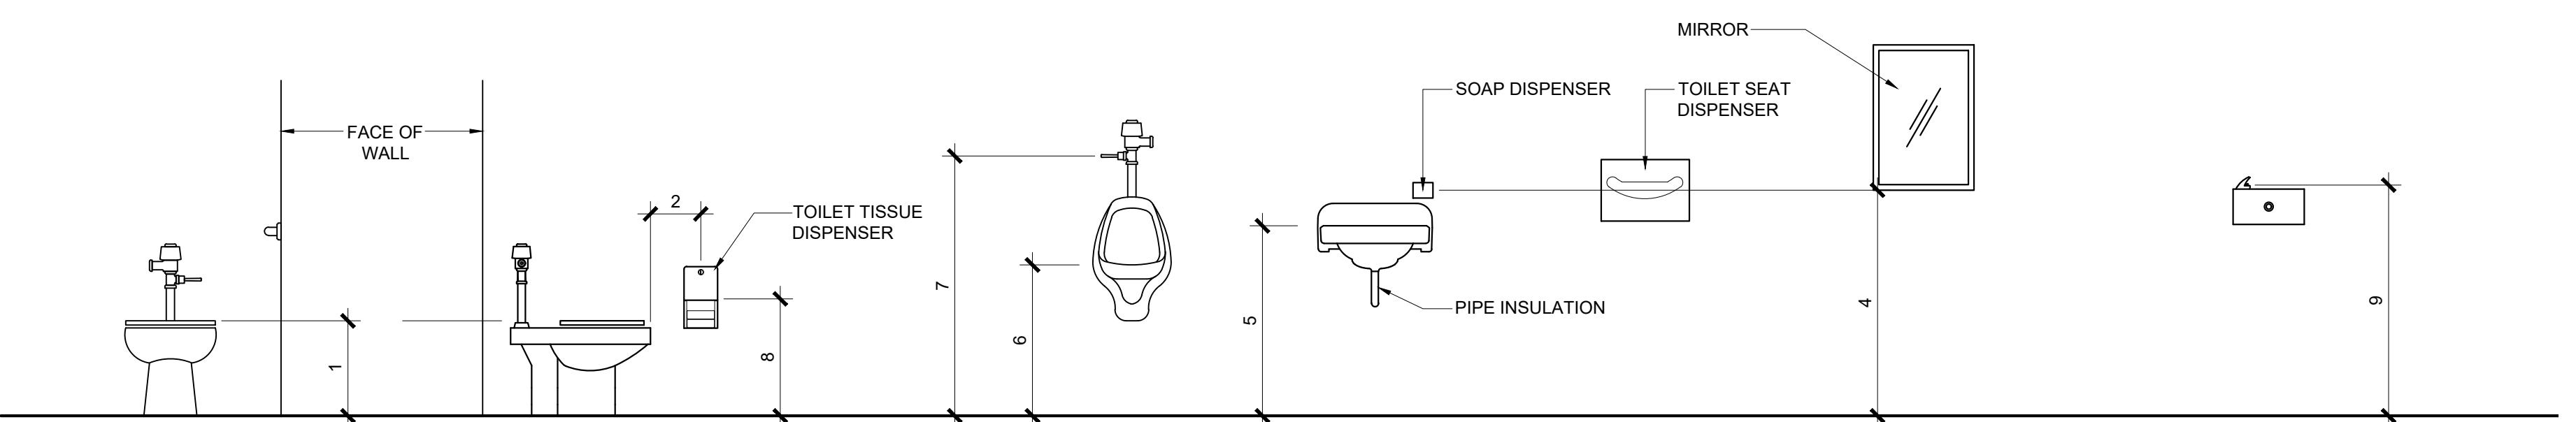

1 MOUNTING HEIGHTS

SCALE: 1/2" = 1'-0"
(E) A# 03-118276

ACCESSIBLE FIXTURES HEIGHT DIMENSIONS		ADULT
A.	TOILET CENTERING FROM WALL	17"-18"
B.	TOILET SEAT HEIGHT TO TOP OF SEAT	17"-19"
C.	GRAB BAR HEIGHT	33"-36"
D.	TOILET PAPER ABOVE FLOOR	19"
E.	TOILET PAPER IN FRONT OF TOILET	7"-9"
F.	NAPKIN DISPOSAL IN FRONT OF TOILET	12" MAX.
G.	DISPENSER HEIGHT	40" MAX.
H.	MIRROR HEIGHT (BOTTOM OF REFLECTIVE SURFACE)	40" MAX. 35" MAX NOT OVER LAV. 34" MAX.
I.	LAVATORY/SINK TOP HEIGHT	34" MAX.
J.	LAVATORY APRON CLEARANCE	29" MIN.
K.	LAVATORY/SINK KNEE CLEARANCE	27" MIN.
L.	URINAL LIP HEIGHT	17" MAX.
M.	URINAL TOILET FLUSH HANDLE HEIGHT	44" MAX.
N.	DRINKING FOUNTAIN BUBBLER HEIGHT	27" MIN.
O.	DRINKING FOUNTAIN KNEE CLEARANCE	27" MIN.
P.	HAND DRYER	40" MAX.

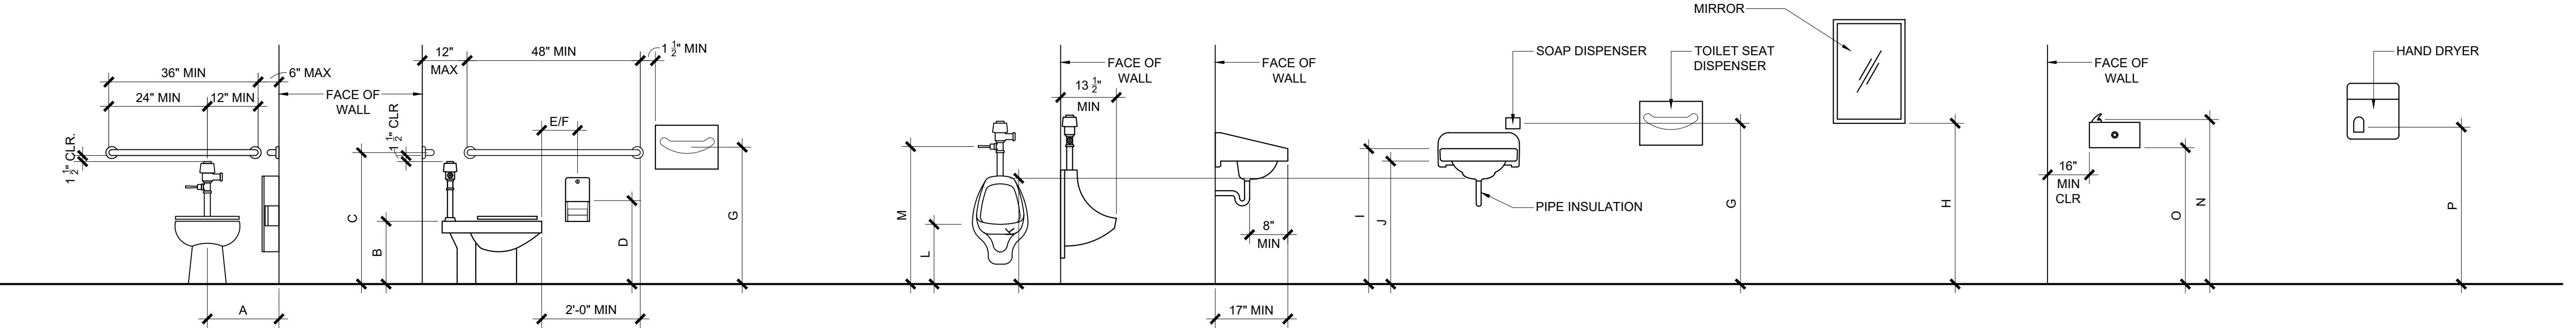

2 MOUNTING HEIGHTS


SCALE: 1/2" = 1'-0"
(E) A# 03-118276

DOOR AND SIGNAGE SCHEDULE

ROOM TYPE	MARK NO	DOOR TYPE	DOOR TYPE						FRAME TYPE			SIGNAGE RE: A8.1		LEGEND			
			INTERIOR	EXTERIOR	WOOD	WIRE MESH	HOLLOW METAL	SIZE	HEIGHT	WIDTH	HARDWARE SET	GLAZING TYPE	DOOR AND FRAME LABEL (MIN)	DETAIL	EXTERIOR SIDE	INTERIOR SIDE	REMARKS
WOMEN'S TOILET	A	B	-	○	-	○	-	3'-0"	7'-0"	1	-	-	-	-	NONE	3/A6.0	3/A6.0
NON-GENDER TOILET	B	B	-	○	-	○	-	3'-0"	7'-0"	1	-	-	20	-	○	-	-
MEN'S TOILET	C	B	-	○	-	○	-	3'-0"	7'-0"	1	-	-	60	-	○	-	-

HARDWARE TYPE 1:

STAFF TOILETS:
LOCK L9 456 TO GN L583-363-L238-722
CORE Z3-030 EV 29T
LEVER SCGLAGE L-SERIES MODEL 06 BOTH SIDES OF DOOR

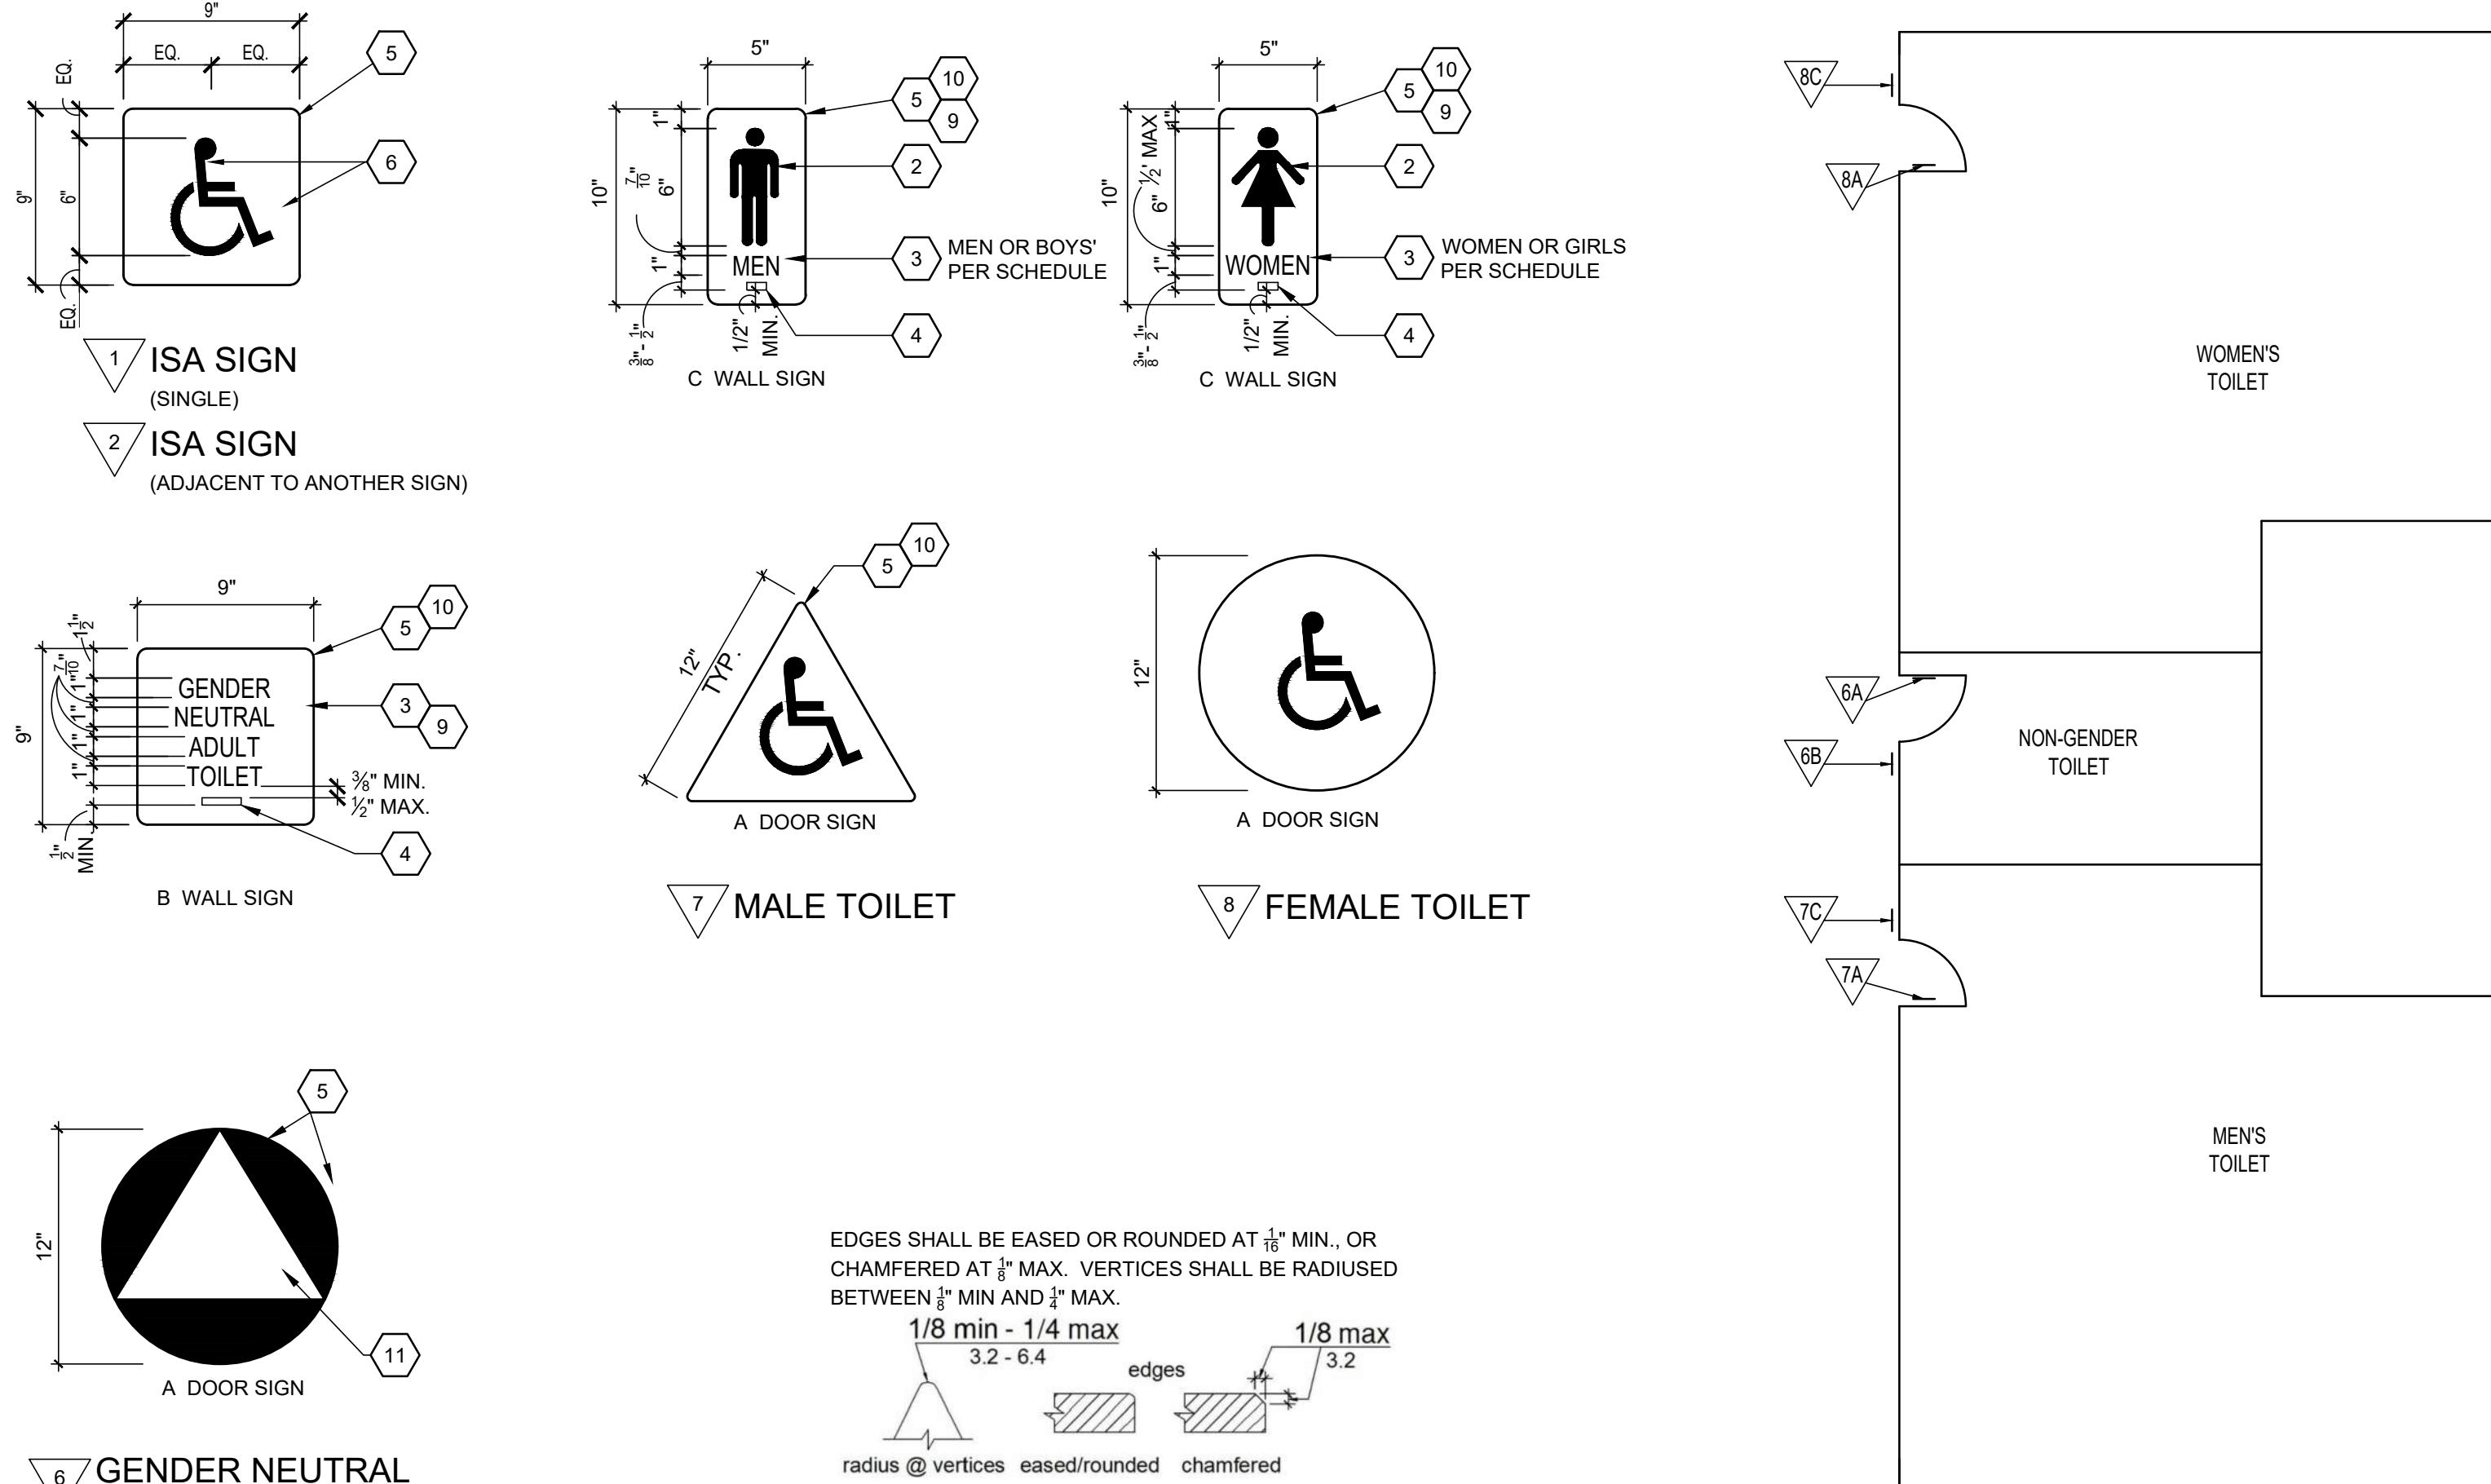

1 SIGNAGE TYPES

SCALE: N.T.S.

2 EDGES & VERTICES ON GRAPHIC SYMBOLS DETAIL

SCALE: N.T.S.

KEYNOTES

- RAISED WHITE ROOM TEXT OR NUMBER, 5/8 INCH TO 4 INCH HIGH & RAISED 1/32 INCH MINIMUM
- RAISED PICTORIAL SYMBOL, 6" HIGH MIN & RAISED 1/32 INCH MINIMUM
- RAISED TEXT, RAISED 1/32 INCH MINIMUM, TEXT TO MATCH FLOOR PLAN
- CALIFORNIA BRAILLE, CONTRACTED GRADE 2, REFER TO TABLE IIB-703.1
- RADIUS CORNER TYPICAL, 1/8" MIN. AND 1/4" MAX, RE: A4.1
- 6" HIGH INTERNATIONAL SYMBOL OF ACCESSIBILITY (ISA) SYMBOL TO BE WHITE, BACKGROUND TO BE COLOR WHITE IN FEDERAL STANDARD 595C. ITS PROPORTIONS SHALL BE PER CBC FIGURE IIB-703.7.2, COMPLY WITH CBC 11B-216.8 & 11B-703.2.4
- INTERNATIONAL SYMBOL OF ACCESS FOR HEARING LOSS SYMBOL, COMPLY WITH CBC 11B-703.7.2.4
- BACKGROUND TO BE COLOR RED
- BACKGROUND TO BE SELECTED BY ARCHITECT, WHERE LETTERING OR SYMBOLS OCCUR, TO BE WHITE
- EDGES SHALL BE EASED OR ROUNDED AT 1/16" MIN. OR CHAMFERED AT 1/8" MIN.
- CONTRASTING COLOR 1/8" THICK TRIANGLE ON 1/8" THICK CIRCLE WHICH IS CONTRASTING COLOR OF DOOR, EDGES AND VERTICES ON GEOMETRIC SYMBOLS SHALL BE EASY OR ROUNDED AT 1/16" MINIMUM OR CHAMFERED AT 1/8" MAX. VERTICES SHALL BE RADIISES BETWEEN 1/8" AND 1/4" MINIMUM
- LETTERING TO BE VISUAL (PER 11B-703.6) NOT RAISED

GENERAL SIGNAGE REQUIREMENTS

CODE REQUIREMENTS:

- FLOOR LEVEL EXIT SIGNS: PER CBC 1011.6 AND 1011.7
- GENERAL REQUIREMENTS: PER CBC 11B-216.1 AND 11B-703.1
- SYMBOLS OF ACCESSIBILITY: PER CBC 11B-703.7.2
- TAKE EXIT SIGNS: PER CBC 1011.4


SIGN CONSTRUCTION AND SIZE:

- SIGN CONSTRUCTION: PLASTIC WITH MILLED TEXT, SYMBOLS AND BRAILLE. CHEMICALLY WELDED OR ADHESIVE APPLIED TEXT, SYMBOLS AND BRAILLE IS NOT ACCEPTABLE.
- FINISH AND CONTRAST: TEXT, SYMBOLS AND THEIR BACKGROUND SHALL HAVE A NON-GLARE FINISH. TEXT AND SYMBOLS SHALL HAVE CONTRAST WITH THEIR BACKGROUND PER 11B-703.5.1 FOR VISUAL CHARACTERS; 11B-703.6.2 FOR PICTOGRAMS; 11B-703.7.1 FOR SYMBOLS OF ACCESSIBILITY.
- SIZES OF SIGNS SHALL BE AS DETAILED PER DRAWING A6.0

PICTORIAL SYMBOLS FOR RESTROOMS AND VISUAL CHARACTERS


- TYPE: RAISED 1/32 INCH MINIMUM
- HEIGHT: 6 INCHES MINIMUM
- TEXT DESCRIPTORS: TEXT SHALL BE LOCATED DIRECTLY BELOW THE PICTOGRAM FILED AND SHALL COMPLY WITH TAICILE TEXT CHARACTERS AND BRAILLE REQUIREMENTS THIS PAGE
- VISUAL CHARACTERS SHALL COMPLY WITH CBC SECTION IIB-703.5 AND SHALL BE 40" MIN. ABOVE FLOOR OR GROUND
- PICTOGRAMS SHALL COMPLY WITH CBC SECTION IIB-703.6
- SYMBOLS OF ACCESSIBILITY SHALL COMPLY WITH CBC SECTION IIB-703.7
- VARIABLE MESSAGE SIGNS SHALL COMPLY WITH CBC SECTION IIB-703.8

MOUNTING DETAILS

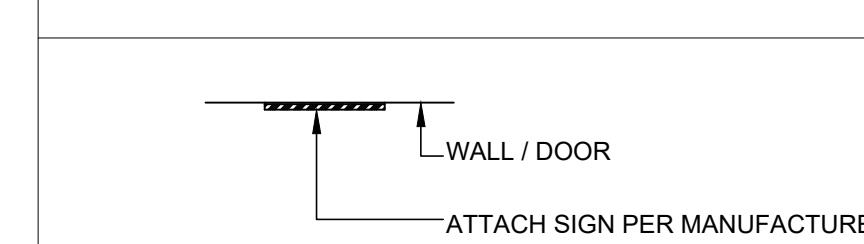


4 WALL OR DOOR MOUNTED SIGNS

SCALE: 1 1/2" = 1'-0"

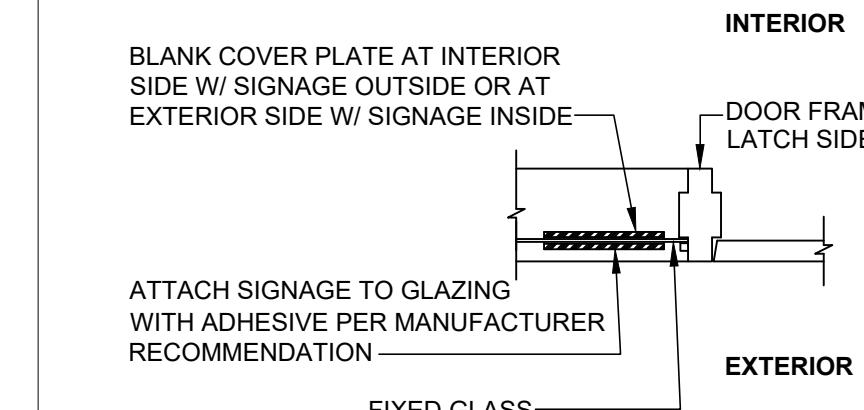

5 GLASS MOUNTED SIGNS

SCALE: 1 1/2" = 1'-0"

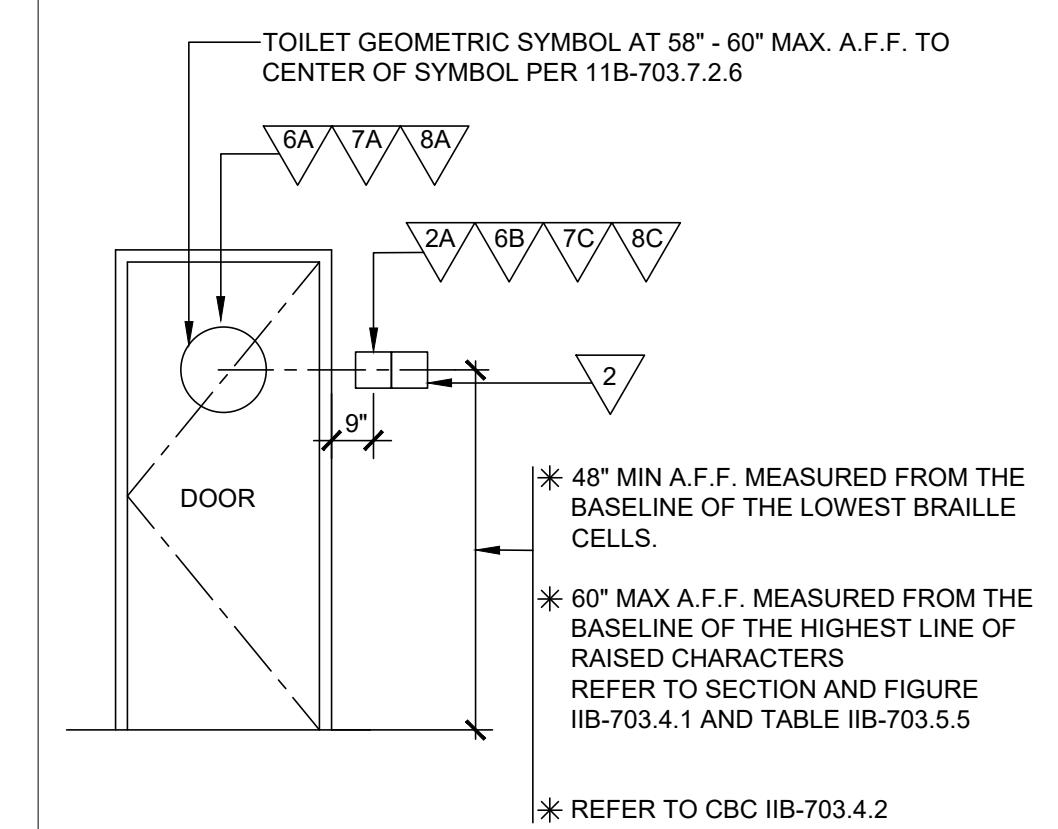


6 DOOR SIGNAGE LOCATIONS

SCALE: NO SCALE

GENERAL NOTES

- REFER TO FLOOR PLANS ON DRAWING A1.2 SERIES FOR DOOR LOCATIONS, ROOM NAME, AND NUMBERS

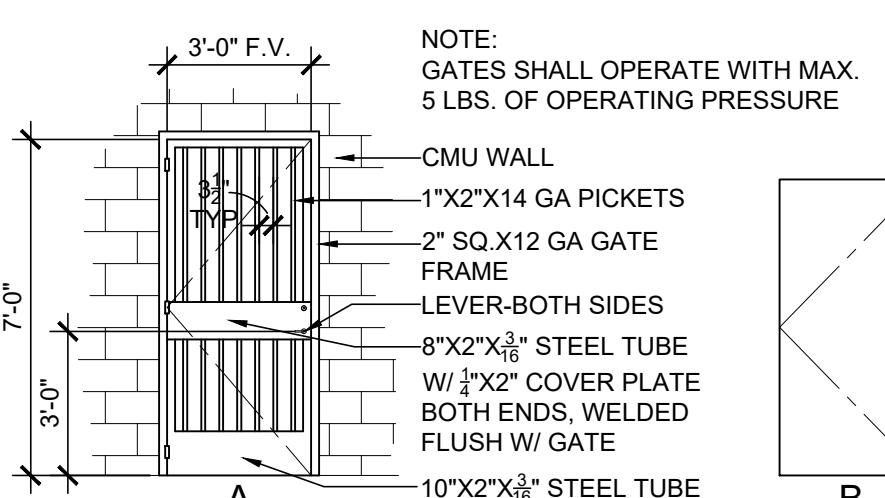

7 EXISTING DOOR AND FRAME

SCALE: 1/4" = 1'-0"

A# 03-118276

GENERAL DOOR NOTES

- MAXIMUM EFFORT TO OPERATE DOORS SHALL NOT EXCEED 5 POUNDS PER 2022 CBC FOR EXTERIOR AND INTERIOR DOORS. SUCH PULL OR PUSH EFFORT BEING APPLIED AT RIGHT ANGLES TO HINGED DOORS AT CENTER PLANE OF SLIDING OR FOLDING DOORS, COMPENSATING DEVICES OR AUTOMATIC DOOR OPERATORS MAY BE UTILIZED TO MEET THE ABOVE STANDARDS. THE AUTHORITY HAVING JURISDICTION MAY INCREASE THE MAXIMUM EFFORT TO OPERATE FIRE DOORS TO ACHIEVE POSITIVE LATCHING, BUT NOT EXCEED 15 POUNDS MAXIMUM. CBC 1133.
- EXIT DOORS SHALL BE OPENABLE AT ALL TIMES FROM THE INSIDE WITHOUT THE USE OF A KEY OR ANY SPECIAL KNOWLEDGE OR EFFORT.
- EMERGENCY EXIT AND PANIC HARDWARE:
 - COMPLIANCE WITH SFM STANDARD 12-10-3, SECTION 12-10-302.
 - THE CROSS-BAR SHALL EXTEND ACROSS NOT LESS THAN ONE-HALF THE WIDTH OF THE DOOR / GATE.

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DRAWING TITLE:
SIGNAGE &
DOOR SCHEDULE

DRAWING NO.:

A6.0